

ELECTRICAL SYMBOL LIST

ø OR PH

NEUTRAL BUS

DIRECTION IF SHOWN

DIRECTION IF SHOWN

WALL MOUNTED LUMINAIRE

WALL MOUNTED LUMINAIRE

BRANCH PANEL

CIRCUIT BREAKER

CURRENT TRANSFORMER

DRY TYPE TRANSFORMER

GROUNDING POINT

METER WITH CONNECTION

SURGE PROTECTION DEVICE

WATER PIPE GROUND CONNECTION

LANDING LUG

<u>Miscellaneous</u>

WALL MOUNTED LUMINAIRE CONNECTED TO

SEAL-OFF FITTING, CROUSE-HINDS EYS OR EQUAL

EXIT SIGN CEILING MOUNTED, ARROW(S) INDICATES

EXIT SIGN WALL MOUNTED, ARROW(S) INDICATES

AREA LUMINAIRE ARM MOUNTED WITH POLE AND

SURFACE OR PENDANT MOUNTED LED 1' X 4' LUMINAIRE

SURFACE OR PENDANT MOUNTED LED 1' X 8' LUMINAIRE,

TO EMERGENCY/LIFE SAFETY CIRCUIT OR WITH INTEGRAL

SURFACE OR PENDANT MOUNTED LED 1' X 8' LUMINAIRE

SURFACE OR PENDANT MOUNTED HI-BAY LED LUMINAIRE

EMERGENCY/LIFE SAFETY CIRCUIT OR WITH INTEGRAL EMERGENCY BATTERY CONNECTED TO UNSWITCHED

BRANCH CIRCUIT WIRING. ARROW INDICATES HOME RUN

TO PANEL WITH CIRCUITS AS NOTED. WIRE SIZE IS #12

MARKS INDICATE PHASE CONDUCTORS. LONG TICK MARKS

INDICATE NEUTRAL CONDUCTORS. A SINGLE CURVED TICK MARK INDICATES INSULATED GREEN GROUND CONDUCTOR.

AWG MINIMUM UNLESS NOTED OTHERWISE. SHORT TICK

SECOND CURVED TICK MARK INDICATES "ISOLATED

GROUND" (GREEN INSULATION WITH YELLOW STRIPE)

DIGITAL TYPE METER WITH VOLTMETER, AMMETER, KW METER, KVA METER, KVAR METER, AND %THD METER

FLUSH MOUNT EQUIPMENT ENCLOSURE AS NOTED

MAIN DISTRIBUTION PANEL / SUB DISTRIBUTION PANEL

SURFACE MOUNT EQUIPMENT ENCLOSURE AS NOTED

FLUSH WALL MOUNTED BRANCH PANEL

EMERGENCY BATTERY CONNECTED TO UNSWITCHED

EMERGENCY LUMINAIRE WITH BATTERY PACK

PHASE

NOTE: This is a standard symbol list and not all items listed may be used.

Abbre	eviations
(E)	EXISTING
	NEW
(N) A	AMPERES, AMBER
AC	ALTERNATING CURRENT, AIR CONDITIONER
AFC	ABOVE FINISHED CEILING
AFF	ABOVE FINISHED FLOOR
AFG	ABOVE FINISHED GRADE
AIC	AVAILABLE INTERRUPTING CAPACITY
AWG	AMERICAN WIRE GAUGE
вс	BARE COPPER
CEC	CALIFORNIA ELECTRICAL CODE
С	CONDUIT, CLOSE, CONTROL
СВ	CIRCUIT BREAKER
CFCI	CONTRACTOR FURNISHED CONTRACTOR INSTALLED
CFOI	CONTRACTOR FURNISHED OWNER INSTALLED
CLG	CEILING
СОМ	COMMUNICATION
CT	CURRENT TRANSFORMER
CU	COPPER
DN	DOWN
EF	EXHAUST FAN
EA	EACH
F	FUSE
FA	FIRE ALARM
FACP	FIRE ALARM CONTROL PANEL
FBO	FURNISHED BY OTHERS
FF	FINISH FLOOR
G, GND	GROUND
GFCI	GROUND FAULT CIRCUIT INTERRUPTER
GFI	GROUND FAULT INTERRUPTER
KVA	KILOVOLT AMPERES
KW	KILOWATT
LED	LIGHT EMITTING DIODE
LTG	LIGHTING
LV	LOW VOLTAGE

MOTOR

MINIMUM CIRCUIT AMPS MOTOR CONTROL CENTER MAIN SWITCHBOARD MT, MTD MOUNT, MOUNTED NEUTRAL NATIONAL ELECTRIC CODE NATIONAL ELECTRICAL MANUFACTURERS ASSOCIATION

NTS NOT TO SCALE OWNER FURNISHED, CONTRACTOR INSTALLED OWNER FURNISHED, OWNER INSTALLED

OCCUPANCY SENSOR PUSHBUTTON, PULLBOX PHASE PANEL

POLY-VINYL-CHLORIDE QTY QUANTITY REF REFERENCE

REQD REQUIRED SURGE PROTECTION DEVICE TELEPHONE TERMINAL BOARD TRANSIENT VOLTAGE SURGE SUPPRESSOR TYP TYPICAL

VARIABLE FREQUENCY DRIVE

UNDERGROUND UNLESS OTHERWISE NOTED VOLTS, VOLTAGE

WITH WATER HEATER WEATHERPROOF TRANSFORMER

Connections / Equipment

CONTACTOR COIL HEAVY DUTY FUSED DISCONNECT SWITCH

JUNCTION BOX (J) OR [J] JUNCTION BOX WITH FLEX CONNECTION TO EQUIPMENT

WALL-MOUNTED JUNCTION BOX MOTOR CONNECTION

NON-FUSED DISCONNECT SWITCH TRANSFORMER

UTILITY METER BASE

Fire Alarm

FIRE ALARM CONTROL PANEL HEAT DETECTOR PULL STATION

PHOTOELECTRIC SMOKE DETECTOR COMBINATION SMOKE ALARM AND CARBON MONOXIDE DETECTOR, SINGLE STATION

SPRINKLER FLOW SWITCH WITH INPUT MODULE

SPRINKLER POST INDICATOR VALVE CONNECTION WITH INPUT MODULE SPRINKLER TAMPER SWITCH WITH INPUT MODULE

EXTERIOR SPRINKLER BELL MAGNETIC DOOR HOLDER STROBE WITH CONDELA RATING

HORN/STOBE WITH CONDELA RATING

HORN

EQUIPMENT IDENTIFICATION

KEYED NOTE

DETAIL NUMBER AND SHEET LOCATION

SECTION NUMBER AND SHEET LOCATION

| X-XX |

<u>Industrial</u>

SITE / ONE-LINE DIAGRAM COORDINATION TAG SPARE CONDUITS

2 - 4"C CONTROL POWER TRANSFORMER

> CONTROL RELAY CURRENT TRANSFORMER AND METER

FUSE, AMPERE SIZE SHOWN

GROUND BUS

NAMEPLATE

<u>Raceways</u>

---- CONDUIT ROUTED BELOW FLOOR / GRADE

_____ CONDUIT CONCEALED IN WALL OR CEILING SPACE

_____ CONDUIT ELLED DOWN CONDUIT ELLED UP

CONDUIT/WIRING CONTINUATION

CONDUIT/WIRING STUBBED OUT WITH END CAP OR INSULATÉD PLASTIC BUSHING

FLEXIBLE CONDUIT ~~~~~ TELEPHONE BACKBOARD

GROUNDING POINT

PULL BOX

Switches and Receptacles

DUPLEX RECEPTACLE (MULTIPLE LETTERS INDICATE MULTIPLE OPTIONS) A = ABOVE COUNTERC = FLUSH CEILING MOUNTEDE = EMERGENCYG = GROUND FAULT CIRCUIT INTERRUPTER T = TAMPER RESISTANT SHUTTERED RECEPTACLE W = WEATHERPROOF CONTINUOUS USE COVER, GFCI PROTECTED, WITH WEATHER-RESISTANT RECEPTACLE

DOUBLE DUPLEX RECEPTACLE. SINGLE RECEPTACLE.

SPECIAL DUTY RECEPTACLE. OCCUPANCY SENSOR (SELF CONTAINED) P = PASSIVE INFRARED

D = DUAL TECHNOLOGYU = ULTRASONIC, 360 DEG RANGE H = ULTRASONIC, HALLWAY PATTERN RECEPTACLE CONTROLLER

LOW VOLTAGE PHOTO SENSOR

LOW VOLTAGE OCCUPANCY SENSOR

SWITCH, SPST 2 = DPST

3 = 3 - WAY4 = 4 - WAYa THRU z (LOWERCASE) = SWITCH CIRCUIT DESIGNATION D = DIMMER

F = FAN SPEED CONTROLK = KEY OPERATED SWITCH

M = MANUAL MOTOR STARTER WITH THERMAL OVERLOAD P = SWITCH WITH PILOT LIGHT

<u>Telecommunications</u>

TELCOM OUTLET. (MULTIPLE LETTERS INDICATE MULTIPLE OPTIONS)

> A = ABOVE COUNTERC = CEILING MOUNTED ABOVE ACCESSIBLE CEILING F = FLUSH CEILING MOUNTED R = SURFACE MOUNTED ON RACEWAY

VERDE DESIGN LANDSCAPE ARCHITECTURE CIVIL ENGINEERING SPORT PLANNING & DESIGN 1843 Iron Point Rd. Suite 140 Folsom, CA 95630 tel: 916.415.6554 fax: 916.415.6525 www.VerdeDesignInc.com

STAMP Date Signed: 4/22/22

CONSULTANT

Stanton W+B PROJECT 21064 11344 Coloma Rd, Suite 445 Gold River, CA 95670

TEL 916.288.6250

www.stantoneng.com

SHEET TITLE

ELECTRICAL COVER SHEET

PROJECT NAME

ROSEVILLE SOCCER COMPLEX

PROJECT ADDRESS


04/29/2022

AS-NOTED ROSEVILLE, CA 95747


SUBMITTAL			DATE
30%	04/29/22		
NO.	REVISIONS		DATE
\bigvee	X X		Х
igwedge			
\triangle			
DRAWN BY		CHECKED BY	
JC		NH	
DATE ISSUED		SCALE	

AS-NOTED

- E0.1 ELECTRICAL COVER SHEET
- EO.2 ONE-LINE DIAGRAM & PRELIMINARY LOAD CALCULATIONS
- E0.3 ELECTRICAL BUILDING PLAN AND DETAILS
- E1.0 OVERALL SITE PLAN ELECTRICAL

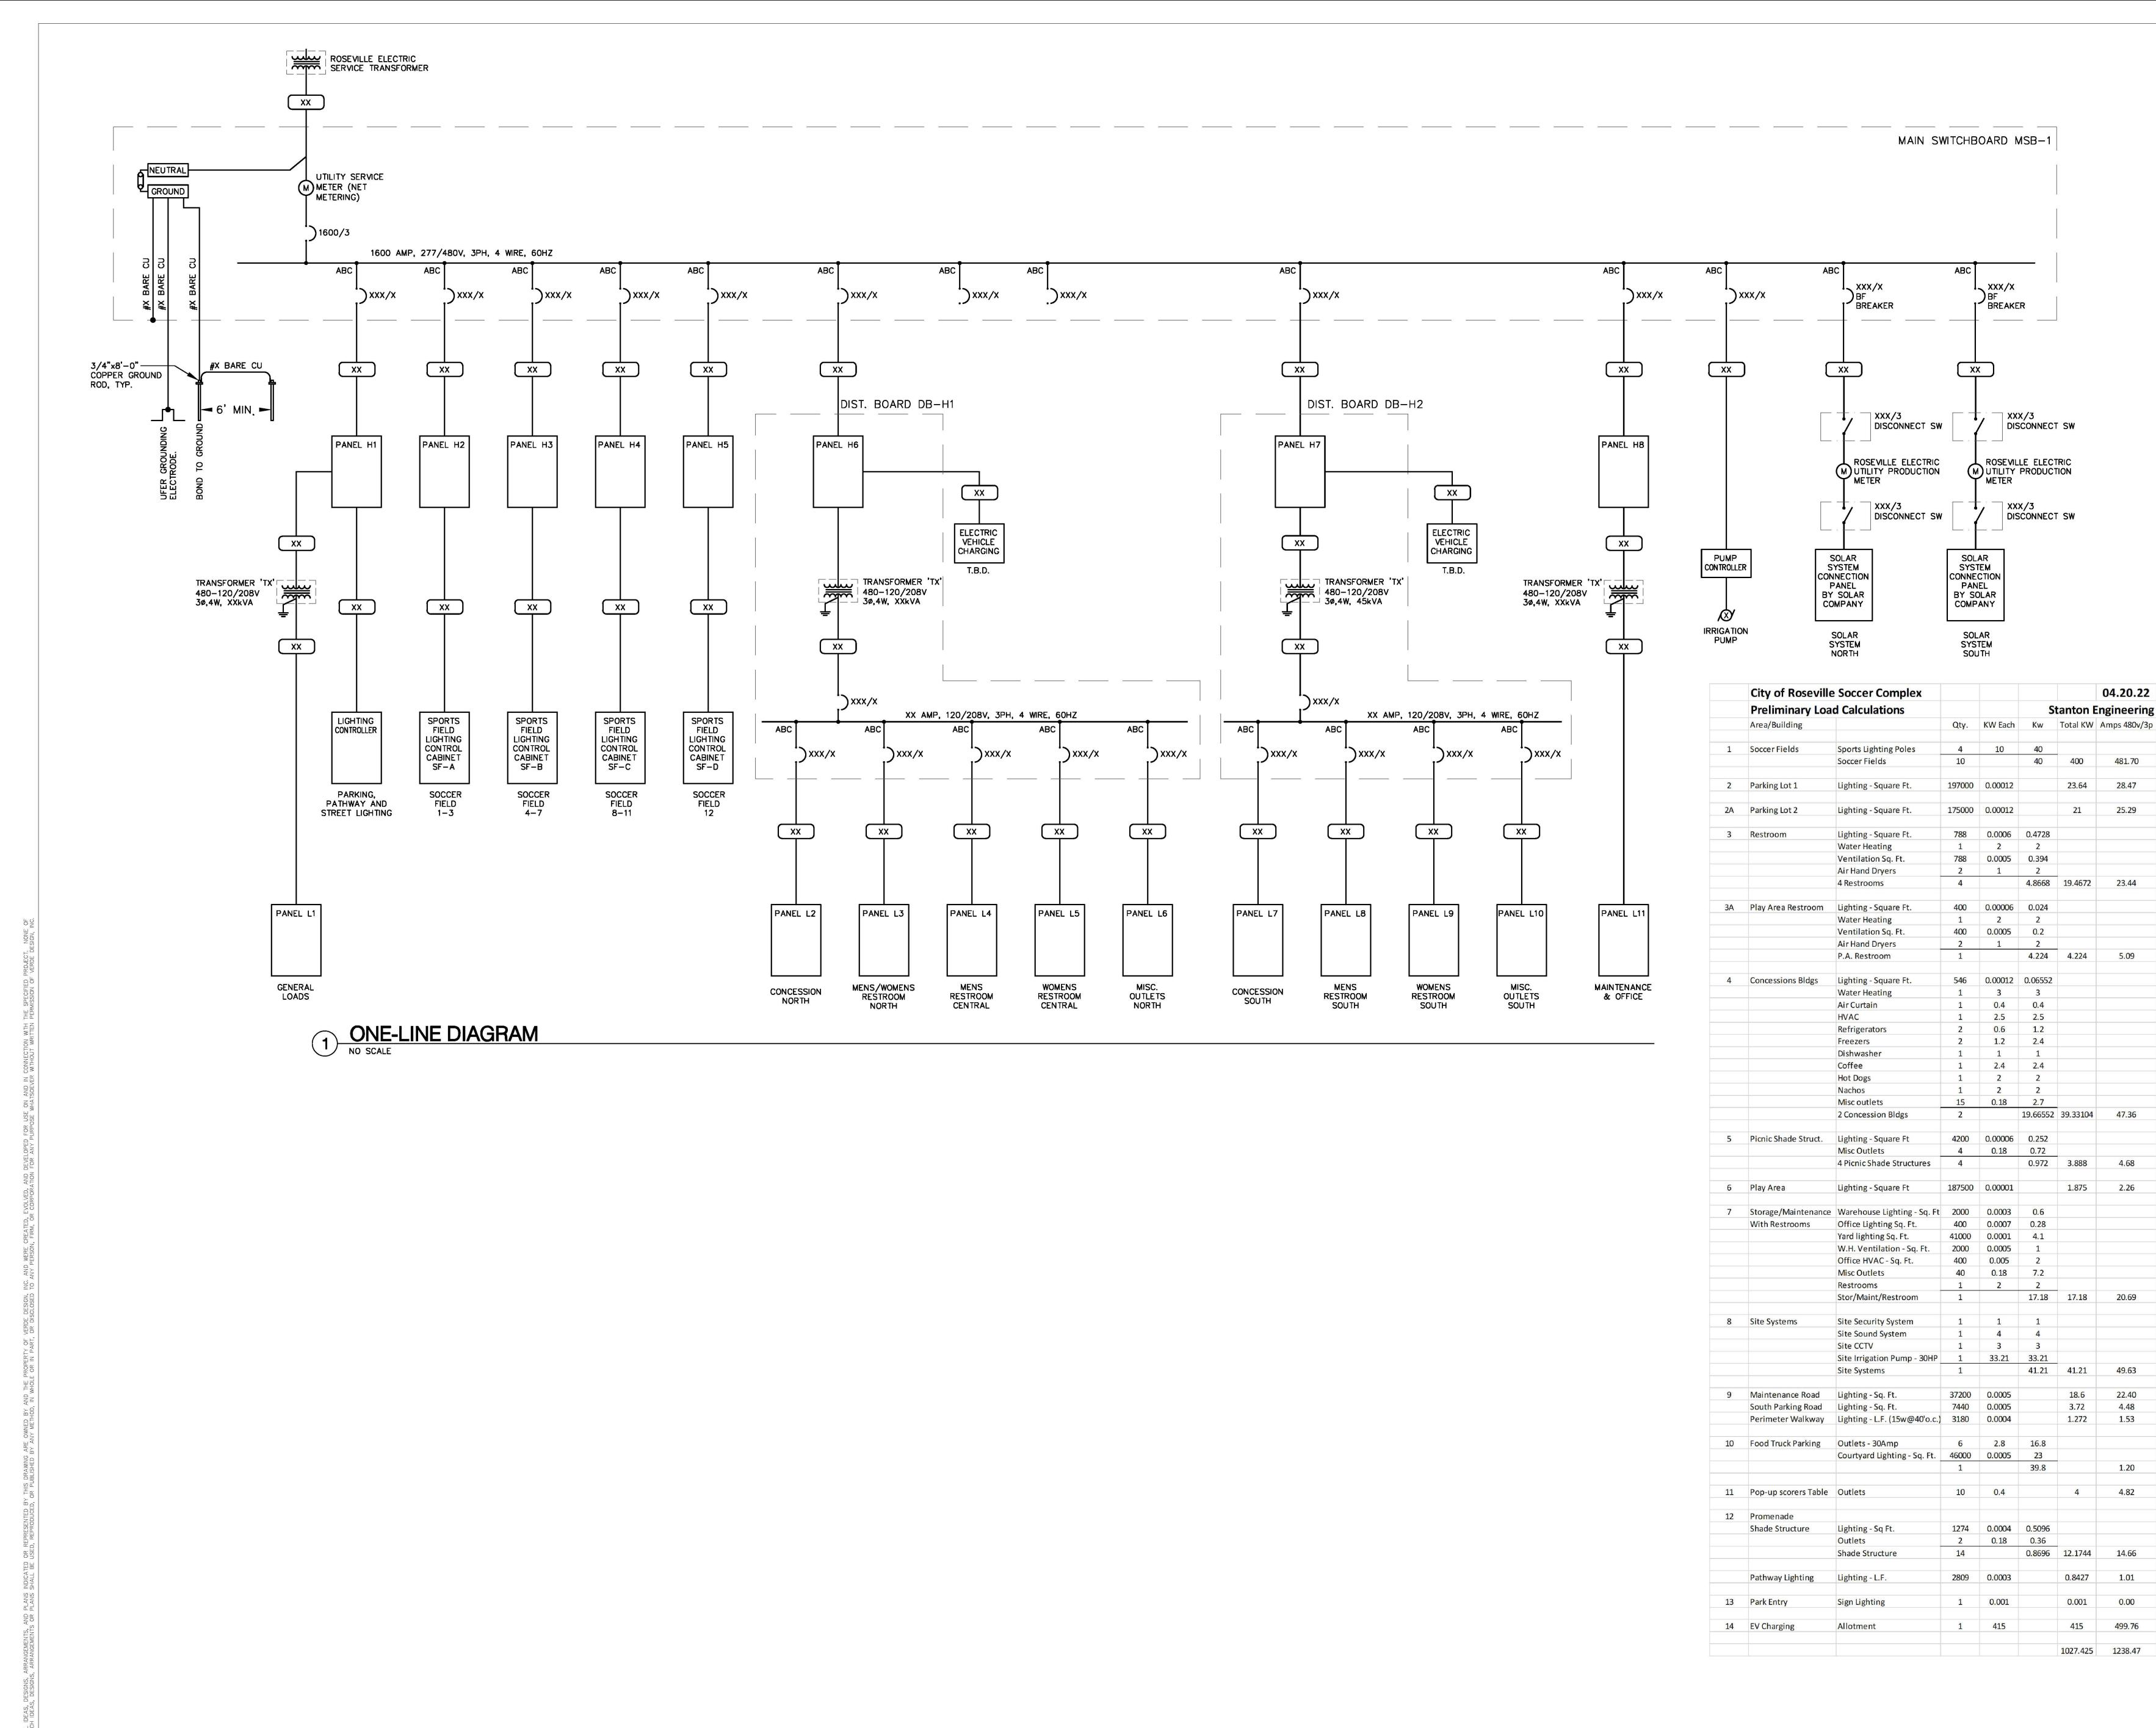



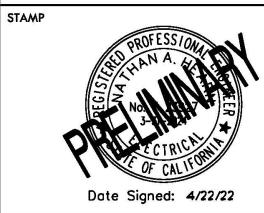

CONSULTANT

PROJECT 21064 11344 Coloma Rd, Suite 445 Gold River, CA 95670 TEL 916.288.6250

www.stantoneng.com

04.20.22

Stanton Engineering

1.875 2.26

18.6

3.72

1.272 1.53

4 4.82

415 499.76

1027.425 1238.47

4.48

400

ONE-LINE DIAGRAM & LOAD CALCULATIONS

PROJECT NAME


ROSEVILLE SOCCER COMPLEX

PROJECT ADDRESS


SUBMITTAL

AS-NOTED ROSEVILLE, CA 95747

30% SUBMITTAL	04/29/22	
NO. REVISIONS		DATE
\ X		х
$\frac{\sim}{\wedge}$		
\wedge		
$\overline{\wedge}$		
\wedge		
$\overline{\wedge}$		
	_	
DRAWN BY	CHECKED BY	2
JRC	NF	1
DATE ISSUED	SCALE	
04/29/2022	AS-NC	OTED
PROJ. NO.	-	
	X	
SHEET NO.		
E0.2		

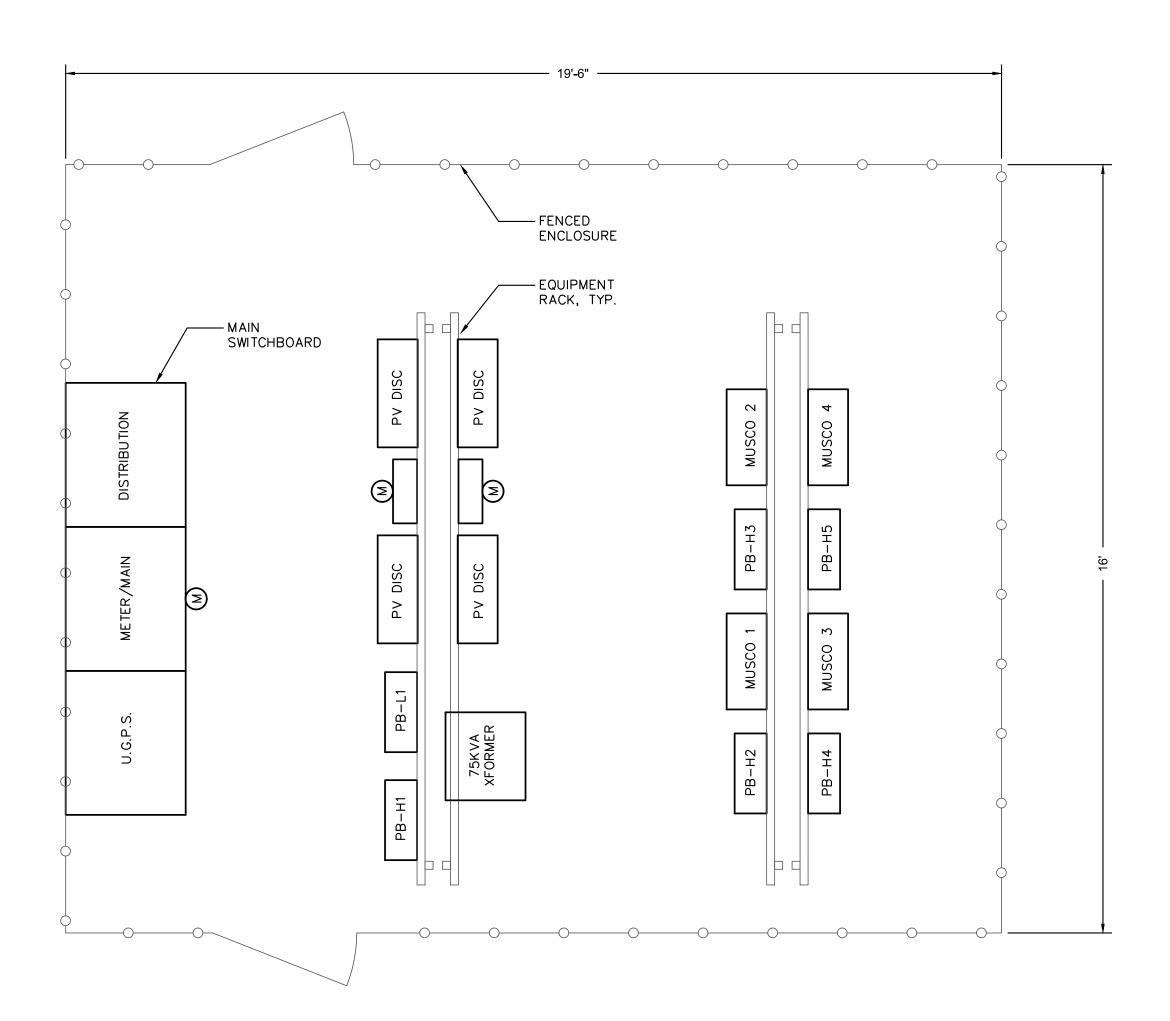


1 ELECTRICAL SERVICE ENCLOSURE PLAN
SCALE: 1/2"=1'-0"

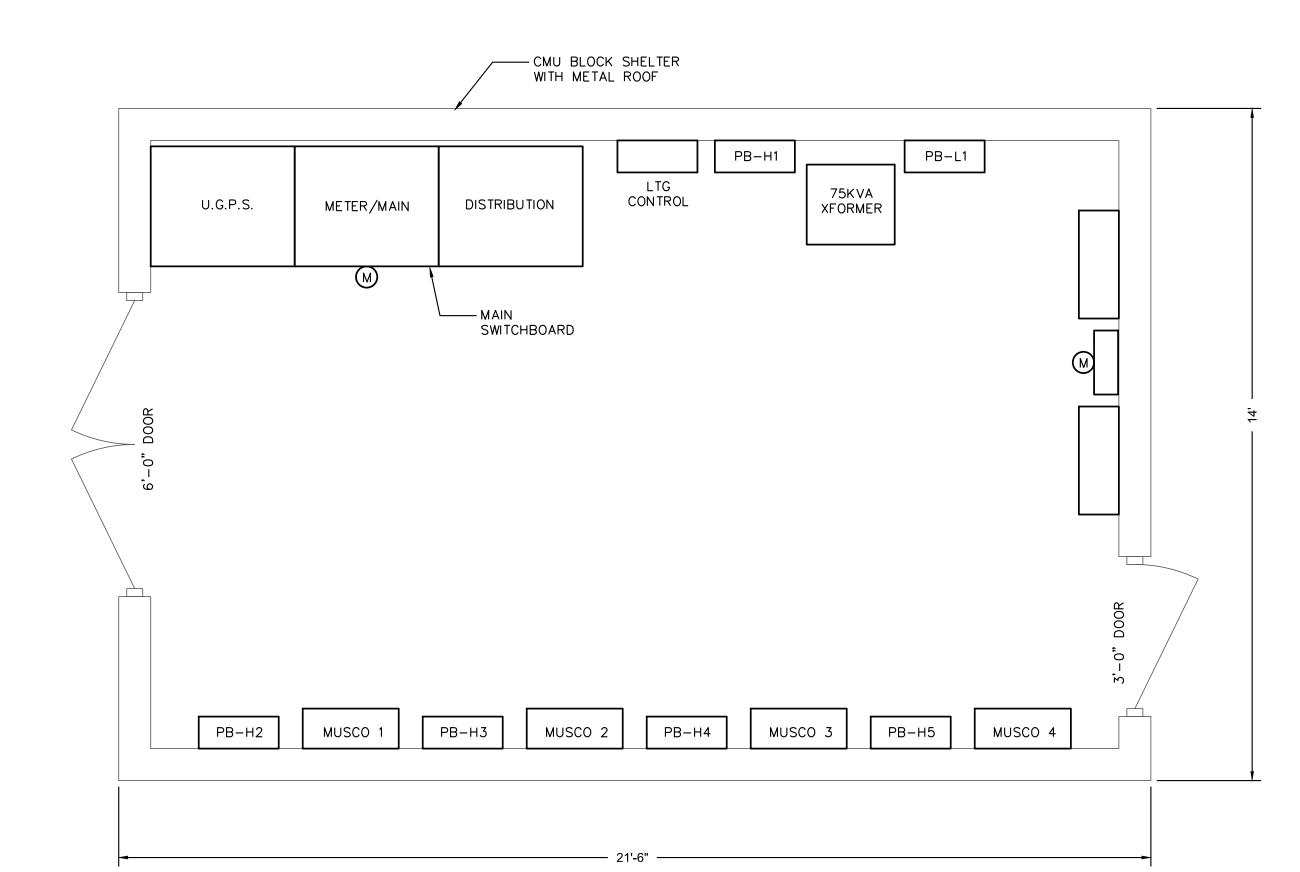

2 ALTERNATE - ELECTRICAL SERVICE SHELTER PLAN

SCALE: 1/2"=1'-0"

0 1' 2' 4'

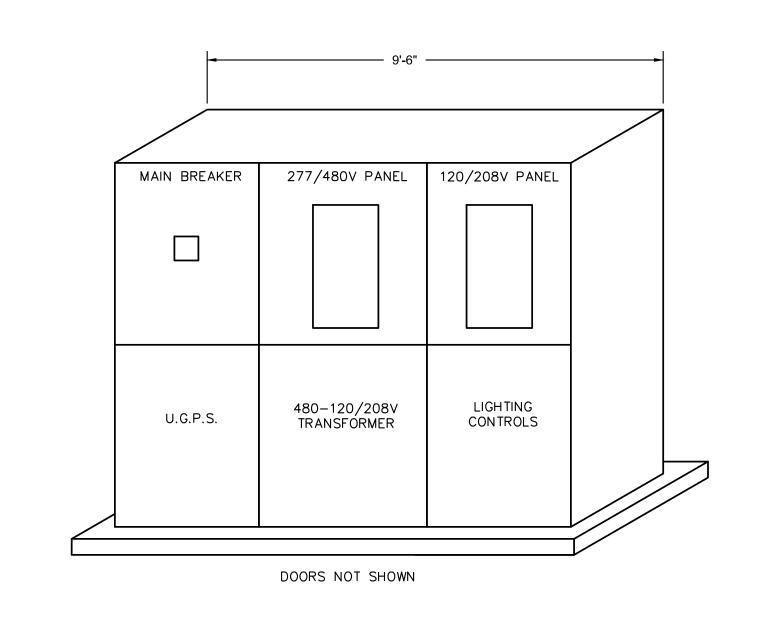

SOUTH SWITCHBOARD DB-H2 SIMILAR

3 ELEVATION - NORTH SWITCHBOARD DB-H1
SCALE: 1/2"=1'-0"

1 1 2' 4'



PROFESSIONAL PROFE

CONSULTANT

PROJECT 21064

11344 Coloma Rd, Suite 445
Gold River, CA 95670
TEL 916.288.6250
www.stantoneng.com

SHEET TITLE

ELECTRICAL BUILDING PLAN AND DETAILS

PROJECT NAME

30% SUBMITTAL

ROSEVILLE SOCCER COMPLEX

PROJECT ADDRESS

A S_NOT

AS-NOTED ROSEVILLE, CA 95747

NO. REVISIONS

A

X

X

X

DATE

X

X

DATE

DATE

NH

DATE

DATE

NH

DATE

SCALE

DATE ISSUED

04/29/2022


PROJ. NO.

X

SHEET NO.

E0.3



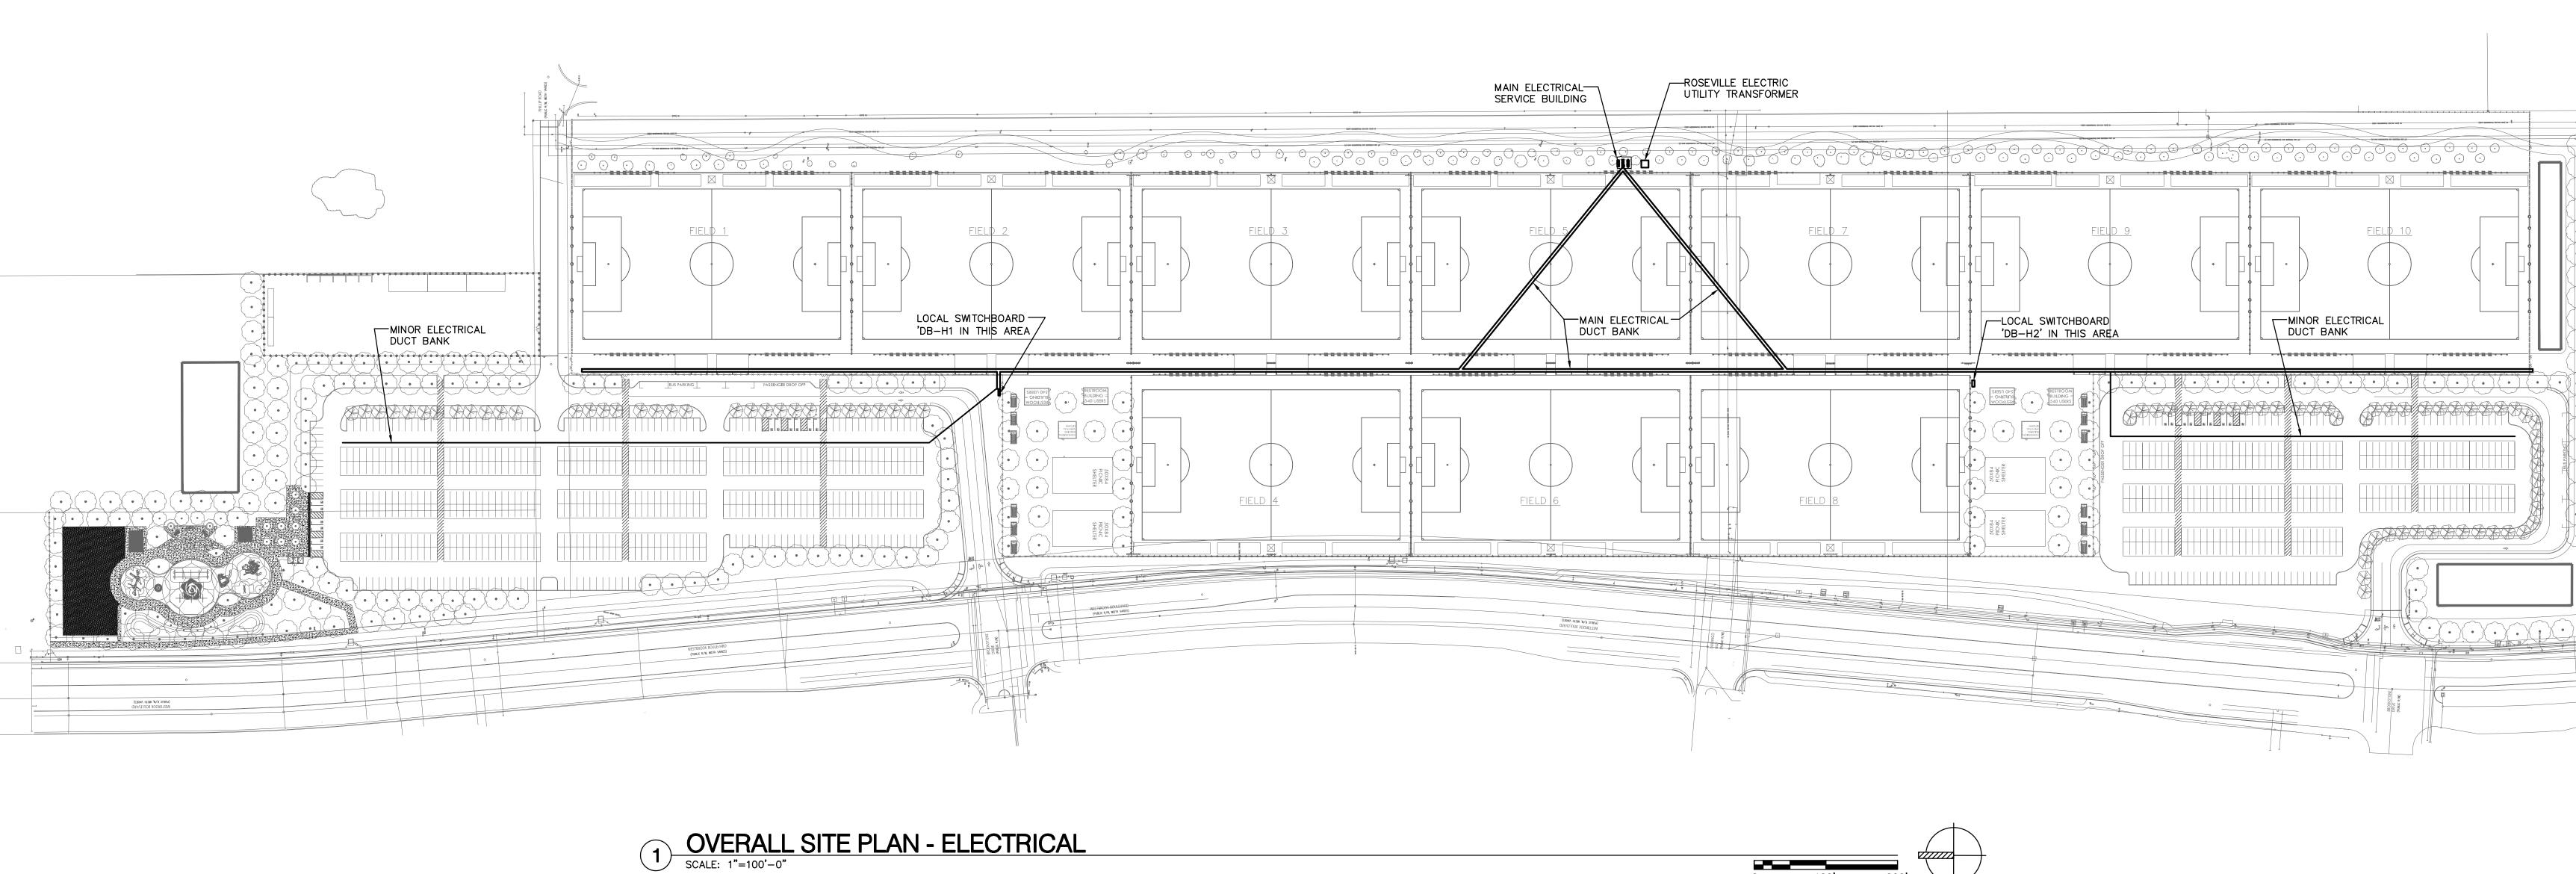

DRAWING NAME: S:\2021\21064 West Roseville Soccer Complex\CAD\Elec\21064_E1.0.dwg
PLOT DATE: 04-22-22 PLOTTED BY: Jerryc