GALLERIA BOULEVARD N/O ROSEVILLE PARKWAY 1101 GALLERIA BOULEVARD ROSEVILLE, CA. 95678

** TITLE REPORT

THIS SURVEY AND EASEMENTS SHOWN HEREON ARE BASED ON INFORMATION CONTAINED IN THE COMMITMENT BY:

FIRST AMERICAN TITLE INSURANCE COMPANY 18500 VON KARMAN AVENUE, SUITE 600 IRVINE, CA 92612 (949) 885-2488 ORDER/FILE NUMBER: NCS-1171026-SA1 DATED: MARCH 09, 2023 TITLE OFFICER: JOSEPH GAUTHIER

** LEGAL DESCRIPTION

REAL PROPERTY IN THE CITY OF ROSEVILLE, COUNTY OF PLACER, STATE OF CALIFORNIA, DESCRIBED AS FOLLOWS:

PARCEL ONE:

PARCEL A, AS SHOWN ON THE MAP ENTITLED "THE GALLERIA AT ROSEVILLE", FILED FOR RECORD DECEMBER 21, 1999 IN BOOK W OF MAPS, AT PAGE 2, PLACER COUNTY

EXCEPTING THEREFROM ALL OIL, GAS, MINERALS, HYDROCARBON AND KINDRED SUBSTANCES LYING BELOW A DEPTH OF 500 FEET AS RESERVED IN THAT CERTAIN DEED RECORDED MAY 5, 1982 IN BOOK 2497, PAGE 696 AND THAT CERTAIN DEED RECORDED JULY 24, 1972 IN BOOK 1432, AT PAGE 305, PLACER COUNTY RECORDS

PARCEL TWO:

A NON-EXCLUSIVE EASEMENT APPURTENANT TO PARCEL ONE ABOVE FOR INGRESS AND EGRESS OF PEDESTRIAN AND VEHICULAR TRAFFIC AS PROVIDED FOR IN SECTION 1 OF THE DECLARATION OF ACCESS EASEMENT AGREEMENT RECORDED NOVEMBER 17. 2000. INSTRUMENT NO. 2000-0088322. PLACER COUNTY RECORDS

NOTE: SAID DOCUMENT ABOVE IS ALSO LISTED HEREON AS EXCEPTION DOCUMENT NO. 11. REFER TO SAID ITEM'S NOTE HEREON REGARDING DOCUMENT'S EFFECT.

GENERAL NOTES

- 1. CONTRACTOR SHALL VERIFY ALL EXISTING FIELD CONDITIONS AND NOTIFY DESIGN ENGINEER OF ANY DISCREPANCIES PRIOR TO CONSTRUCTION.
- 2. CONTRACTOR TO VERIFY POINTS OF CONNECTION TO PIPES, INLETS, CURBS, GUTTERS, ETC. AND NOTIFY TRUXAW AND ASSOCIATES OF ANY DISCREPANCIES PRIOR TO CONSTRUCTION.
- 3. REFER TO ARCHITECTURAL PLANS FOR BUILDING DIMENSIONS, BUILDING SETBACKS, CONCRETE COLORS AND FINISHES, STRUCTURAL DETAILS, WALKWAYS, EXPANSION JOINT LOCATIONS, UTILITIES, ETC.
- 4. ALL WORK SHALL BE DONE IN STRICT CONFORMANCE WITH CURRENT CITY OF ROSEVILLE AND SPPWC STANDARDS. WORK SHALL ALSO CONFORM TO APPLICABLE BUILDING CODES (CA BUILDING CODE, CA PLUMBING CODE, ETC.) AS INTERPRETED BY THE CITY OF ROSEVILLE.
- 5. ALL CONTRACTORS PERFORMING WORK ON THIS PROJECT SHALL FAMILIARIZE THEMSELVES WITH THE SITE AND SHALL BE SOLELY RESPONSIBLE FOR ANY DAMAGE TO EXISTING FACILITIES RESULTING DIRECTLY OR INDIRECTLY FROM THEIR OPERATIONS, WHETHER OR NOT SHOWN ON THESE PLANS.
- 6. EXISTING UNDERGROUND UTILITY LINE LOCATIONS WERE TAKEN FROM AVAILABLE RECORDS. OTHER UTILITIES MAY EXIST THAT ARE NOT PLOTTED HEREON.
- 7. EXISTING UNDERGROUND UTILITIES ARE TO BE RELOCATED AS REQUIRED TO AVOID CONFLICT WITH PROPOSED STRUCTURES.
- 8. EXISTING PUBLIC UTILITY EASEMENTS IN CONFLICT WITH PROPOSED STRUCTURES ARE TO BE QUITCLAIMED WITH THE APPROVAL OF THE UTILITY COMPANY. NEW EASEMENTS ARE TO BE GRANTED AT PROPOSED UTILITY LOCATIONS.
- 9. CALL UNDERGROUND SERVICE ALERT FOR UNDERGROUND LOCATIONS 48 HOURS BEFORE YOU DIG. 811
- 10. THE CONTRACTOR SHALL RENEW OR REPLACE ANY EXISTING TRAFFIC STRIPING AND/OR PAVEMENT MARKINGS, WHICH DURING HIS OPERATIONS HAVE BEEN EITHER REMOVED OR THE EFFECTIVENESS OF WHICH HAS BEEN REDUCED.
- 11. THE CONTRACTOR SHALL COMPLY WITH THE SOILS REPORT (AND ADDENDA) FOR THIS PROJECT AND ALL RECOMMENDATIONS FROM THE SOILS ENGINEER.
- 12. ALL TOPOGRAPHIC AND BOUNDARY INFORMATION SHOWN HEREON WAS OBTAINED FROM AN ALTA/ACSM TITLE SURVEY DATED JUNE 28, 2023 BY TRUXAW AND ASSOCIATES, INC.
- 13. ALL STORM DRAIN AND SEWER PIPE SHALL BE PLACED BEGINNING AT THE DOWNSTREAM POINT OF CONNECTION AND CONTINUING TO THE UPSTREAM TERMINUS. PIPE PLACEMENT SHALL BE CONTINUOUS. DEVIATIONS FROM THIS SEQUENCE WILL NOT BE PERMITTED. POTHOLING INFORMATION, WHERE REQUIRED, SHALL BE OBTAINED AND PROVIDED TO TRUXAW AND ASSOCIATES PRIOR TO CONSTRUCTION.
- 14. ALL IMPROVEMENTS BEYOND THE LIMITS OF GRADING ARE TO BE PROTECTED IN PLACE UNLESS NOTED OTHERWISE.
- 15. THESE PLANS ARE BASED ON THE SITE PLAN PROVIDED TO TRUXAW AND ASSOCIATES, DATED OCTOBER 23, 2023.
- 16. CONSTRUCTION EQUIPMENT WITH INTERNAL COMBUSTION ENGINES SHALL BE EQUIPPED WITH MUFFLERS, SILENCERS, OR OTHER NOISE-MITIGATING DEVICE THAT ARE NO LESS EFFECTIVE THAN THOSE ORIGINALLY INSTALLED BY THE MANUFACTURER.

** EXCEPTIONS, EASEMENT AND DISPOSITION NOTES

- REFER TO TITLE REPORT FOR ADDITIONAL INFORMATION AND DETAILS:
- GENERAL AND SPECIAL TAXES AND ASSESSMENTS FOR THE FISCAL YEAR 2023-2024, A LIEN NOT YET DUE OR PAYABLE.
- THE LIEN OF SPECIAL TAX ASSESSED PURSUANT TO CHAPTER 2.5 COMMENCING WITH SECTION 53311 OF THE CALIFORNIA GOVERNMENT CODE FOR COMMUNITY FACILITIES DISTRICT 1, AS DISCLOSED BY NOTICE OF SPECIAL TAX LIEN RECORDED DECEMBER 26, 1990 AS INSTRUMENT NO. 1990-082362 OF OFFICIAL RECORDS.
- THE LIEN OF SUPPLEMENTAL TAXES, IF ANY, ASSESSED PURSUANT TO CHAPTER 3.5 COMMENCING WITH SECTION 75 OF THE CALIFORNIA REVENUE AND TAXATION CODE.
- AN EASEMENT SHOWN OR DEDICATED ON THE MAP OF TRACT MAP RECORDED AND ON FILE IN BOOK R, PAGE(S) 24, OF TRACT MAPS. FOR: PUBLIC UTILITIES AND INCIDENTAL PURPOSES.
- NOTE: SAID EXCEPTION DOCUMENT, AFFECTS THE SURVEYED LAND AND IS PLOTTED HEREON. REFER TO SAID DOCUMENT FOR FULL PARTICULARS.
- **★** 5 THE TERMS AND PROVISIONS CONTAINED IN THE DOCUMENT ENTITLED "DEVELOPMENT AGREEMENT" RECORDED OCTOBER 16, 1990 AS INSTRUMENT NO. 1990-067309 OF OFFICIAL RECORDS.

DOCUMENT(S) DECLARING MODIFICATIONS THEREOF RECORDED JUNE 18, 1991 AS INSTRUMENT NO. 1991-035023 OF OFFICIAL RECORDS.

DOCUMENT(S) DECLARING MODIFICATIONS THEREOF RECORDED NOVEMBER 07, 1995 AS INSTRUMENT NO. 1995-059717 OF OFFICIAL RECORDS.

- * 6 THE TERMS AND PROVISIONS CONTAINED IN THE DOCUMENT ENTITLED "REGIONAL 65 CENTRE SUPPLEMENTAL DEVELOPMENT AGREEMENT (THE ELEMENTARY SCHOOL TRIPARTITE AGREEMENT)" RECORDED OCTOBER 16, 1990 AS INSTRUMENT NO. 1990-067310 OF OFFICIAL RECORDS.
- **★** 7 THE TERMS AND PROVISIONS CONTAINED IN THE DOCUMENT ENTITLED "DEVELOPMENT AGREEMENT" RECORDED AUGUST 18, 1997 AS INSTRUMENT NO. 1997-0048851 OF OFFICIAL RECORDS.
- AN EASEMENT SHOWN OR DEDICATED ON THE MAP OF TRACT MAP RECORDED DECEMBER 21, 1999 AND ON FILE IN BOOK W, PAGE(S) 2, OF TRACT MAPS. FOR: PUBLIC UTILITIES, PEDESTRIAN EASEMENT, GRADE SEPARATED INTERCHANGE AND IRREVOCABLE OFFER OF DEDICATION, WATER LINE, SANITARY SEWER AND INCIDENTAL PURPOSES.
- NOTE: SAID EXCEPTION DOCUMENT, AFFECTS THE SURVEYED LAND AND IS PLOTTED HEREON. REFER TO SAID TRACT MAP FOR FULL PARTICULARS.
- THE TERMS, PROVISIONS AND EASEMENT(S) CONTAINED IN THE DOCUMENT ENTITLED "UTILITIES EASEMENT AGREEMENT" RECORDED JANUARY 21, 2000 AS INSTRUMENT NO. 2000-0004124 OF OFFICIAL RECORDS.
- NOTE: SAID EXCEPTION DOCUMENT, AFFECTS THE SURVEYED LAND WITH ITEMS PERTAINING TO THE DEVELOPMENT OF A SHOPPING CENTER AND IS BLANKET IN NATURE WITH NO PLOTTABLE MATTERS OF RECORD. REFER TO SAID DOCUMENT FOR FULL PARTICULARS.
- 10 THE TERMS AND PROVISIONS CONTAINED IN THE DOCUMENT ENTITLED "DECLARATION OF RESTRICTIONS AND AGREEMENT" RECORDED JANUARY 21. 2000 AS INSTRUMENT NO. 2000-0004127 OF OFFICIAL RECORDS.
- NOTE: SAID EXCEPTION DOCUMENT. AFFECTS THE SURVEYED LAND WITH REQUIREMENTS AND RESTRICTIONS PERTAINING TO THE DEVELOPMENT OF A SHOPPING CENTER (INCLUDING A MAXIMUM BUILDING HEIGHT OF 30' FOR SUBJECT PARCEL A) AND IS BLANKET IN NATURE WITH NO PLOTTABLE MATTERS OF RECORD. REFER TO SAID DOCUMENT FOR FULL PARTICULARS.
- THE TERMS, PROVISIONS AND EASEMENT(S) CONTAINED IN THE DOCUMENT ENTITLED "DECLARATION OF ACCESS EASEMENT AGREEMENT" RECORDED NOVEMBER 17, 2000 AS INSTRUMENT NO. 2000-0088322 OF OFFICIAL
- NOTE: SAID EXCEPTION DOCUMENT, AFFECTS THE SURVEYED LAND WITH ITEMS PERTAINING TO THE DEVELOPMENT OF A SHOPPING CENTER, INCLUDING AMONG OTHER ITEMS, RESERVATIONS FOR MAINTENANCE AND PERPETUAL ACCESS EASEMENTS AND IS BLANKET IN NATURE WITH NO PLOTTABLE MATTERS OF RECORD. REFER TO SAID DOCUMENT FOR FULL PARTICULARS.
- THE TERMS, PROVISIONS AND EASEMENT(S) CONTAINED IN THE DOCUMENT ENTITLED "DECLARATION OF FREE-STANDING SIGN EASEMENT" RECORDED FEBRUARY 28, 2001 AS INSTRUMENT NO. 2001-0016686 OF OFFICIAL RECORDS.

THE ABOVE DOCUMENT WAS RE-RECORDED NOVEMBER 09, 2001 IN/AS INSTRUMENT NO. 2001-0118246 OF OFFICIAL RECORDS

NOTE: SAID EXCEPTION DOCUMENT, AFFECTS THE SURVEYED LAND AND IS PLOTTED HEREON. REFER TO SAID DOCUMENT FOR FULL PARTICULARS.

- 13 COVENANTS, CONDITIONS, RESTRICTIONS AND EASEMENTS IN THE DOCUMENT RECORDED FEBRUARY 28, 2001 AS INSTRUMENT NO. 2001-0016687 OF OFFICIAL RECORDS, BUT DELETING ANY COVENANT, CONDITION OR RESTRICTION INDICATING A PREFERENCE, LIMITATION OR DISCRIMINATION BASED ON RACE, COLOR, RELIGION, SEX, HANDICAP, FAMILIAL STATUS, NATIONAL ORIGIN. SEXUAL ORIENTATION. MARITAL STATUS. ANCESTRY. SOURCE OF INCOME OR DISABILITY, TO THE EXTENT SUCH COVENANTS CONDITIONS OR RESTRICTIONS VIOLATE TITLE 42. SECTION 3604(C). OF THE UNITED STATES CODES. LAWFUL RESTRICTIONS UNDER STATE AND FEDERAL LAW ON THE AGE OF OCCUPANTS IN SENIOR HOUSING OR HOUSING FOR OLDER PERSONS SHALL NOT BE CONSTRUED AS RESTRICTIONS BASED ON FAMILIAL STATUS.
- NOTE: SAID EXCEPTION DOCUMENT, AFFECTS THE SURVEYED LAND, IS NOT A SURVEY ITEM WITH NO PLOTTABLE MATTERS. REFER TO SAID DOCUMENT FOR FULL PARTICULARS.

** EXCEPTIONS, EASEMENT AND DISPOSITION NOTES - CONT.

14 TERMS AND PROVISIONS OF AN UNRECORDED LEASE DATED SEPTEMBER 01, 2000, BY AND BETWEEN BR OF WISCONSIN 27, LLC. A WISCONSIN LIMITED LIABILITY COMPANY AS LESSOR AND PIER 1 IMPORTS (U.S.), INC., A DELAWARE CORPORATION AS LESSEE, AS DISCLOSED BY A MEMORANDUM OF LEASE RECORDED OCTOBER 30, 2000 AS INSTRUMENT NO. 2000-0081635 OF OFFICIAL RECORDS.

DEFECTS, LIENS, ENCUMBRANCES OR OTHER MATTERS AFFECTING THE

NOTE: SAID EXCEPTION DOCUMENT, AFFECTS THE SURVEYED LAND, IS NOT A SURVEY ITEM

* 15 A DEED OF TRUST TO SECURE AN ORIGINAL INDEBTEDNESS OF \$1,700,000.00 RECORDED SEPTEMBER 2, 2011 AS INSTRUMENT NO. 2011-0068544 OF

> TRUSTOR: GALLERIA BOULEVARD LLC, A CALIFORNIA LIMITED LIABILITY COMPANY FIRST AMERICAN TITLE INSURANCE COMPANY, A CORPORATION BENEFICIARY: SYMETRA LIFE INSURANCE COMPANY, A WASHINGTON CORPORATION

A DOCUMENT ENTITLED "ASSIGNMENT OF LEASES AND RENTS" RECORDED SEPTEMBER 2, 2011 AS INSTRUMENT NO. 2011-0068545 OF OFFICIAL RECORDS, AS ADDITIONAL SECURITY FOR THE PAYMENT OF THE INDEBTEDNESS SECURED BY THE DEED OF TRUST.

THE EFFECT OF A DOCUMENT ENTITLED "RELEASE (ASSIGNMENT OF RENTS)", RECORDED JULY 8, 2021 AS INSTRUMENT NO. 2021-0087352-00 OF OFFICIAL

THE EFFECT OF A DOCUMENT ENTITLED "FULL RECONVEYANCE (DEED OF

NOTE: THE COMPANY WILL REQUIRE SATISFACTORY PROOF OF FULL PAYMENT OF THE DEBT SECURED BY SAID MORTGAGE OR DEED OF TRUST PRIOR TO

- 16 AN ALTA/NSPS SURVEY OF RECENT DATE WHICH COMPLIES WITH THE CURRENT MINIMUM STANDARD DETAIL REQUIREMENTS FOR ALTA/NSPS LAND TITLE SURVEYS.
- 17 WATER RIGHTS, CLAIMS OR TITLE TO WATER, WHETHER OR NOT SHOWN BY THE PUBLIC RECORDS.
- * = SAID EXCEPTION DOCUMENT IS NOT A SURVEY ITEM WITH NO PLOTTABLE MATTERS. REFER TO SAID DOCUMENT FOR FULL PARTICULARS.

** BENCHMARK

3-1/4" BRASS DISK STAMPED 2018 PLS 8278, TOP OF CURB WEST SIDE OF D.I. ON SOUTH SIDE OF ROSEVILLE PARKWAY, APPROX. 270' + EAST OF THE SOUTH INTERSECTION OF GIBSON

** BASIS OF BEARINGS

THE BEARING OF NORTH 00°16'08" WEST ALONG THE CENTERLINE OF HARDING BOULEVARD PER FINAL MAP OF THE GALLERIA AT ROSEVILLE REGIONAL MALL, FILED IN BOOK W, PAGE 2 OF MAPS, IN THE CITY OF ROSEVILLE, COUNTY OF PLACER, STATE OF CALIFORNIA, WAS USED AS THE BASIS OF BEARINGS FOR THIS SURVEY.

** RECORD REFERENCES

(R) = FINAL MAP OF THE GALLERIA AT ROSEVILLE REGIONAL MALL, BOOK W OF MAPS, PAGE 2

SUBJECT PARCEL "A" SHOWN PER TITLE REPORT DESCRIPTION CONTAINS APPROXIMATELYS 77,145 SQ. FT. OR 1.77 ACRES

SOURCE OF BOUNDARY & EASEMENT INFORMATION. ** THE TOPOGRAPHIC INFORMATION SHOWN ON THESE PLANS

DATE OF SURVEY: JUNE 28, 2023

ALTA SURVEY BY:

(714) 935-0265 JOB # BLB23026

CITY OF

LEASEHOLD ESTATE, WHETHER OR NOT SHOWN BY THE PUBLIC RECORDS ARE NOT SHOWN HEREIN.

WITH NO PLOTTABLE MATTERS. REFER TO SAID DOCUMENT FOR FULL PARTICULARS.

OFFICIAL RECORDS.

TRUST)". RECORDED JULY 8, 2021 AS INSTRUMENT NO. 2021-0087355-00 OF

REMOVING THIS EXCEPTION OR INSURING THE CONTEMPLATED TRANSACTION.

- ANY FACTS, RIGHTS, INTERESTS OR CLAIMS WHICH WOULD BE DISCLOSED BY A CORRECT ALTA/NSPS SURVEY.
- 19 RIGHTS OF PARTIES IN POSSESSION.

CITY OF ROSEVILLE BENCHMARK 47

ELEVATION: 173.650 FEET (NAVD88)

** SITE AREA

WERE TAKEN FROM THE PLAN REFERENCED BELOW.

TRUXAW AND ASSOCIATES, INC. 1915 W. ORANGEWOOD AVE., SUITE 101 ORANGE, CA 92868

ROCKLIN ROSEVILLE VICINITY MAP NOT TO SCALE ROSEVILLE PARKWAY

SHEET

TITLE

TITLE SHEET CONCEPTUAL SITE PLAN CONCEPTUAL GRADING PLAN

CONCEPTUAL UTILITY PLAN

TOPOGRAPHIC & BOUNDARY SURVEY TITLE SHEET BOUNDARY SURVEY TOPOGRAPHIC SURVEY

FOR REFERENCE ONLY ***

lo. 75205

NOTICE TO CONTRACTOR THE CONTRACTOR SHALL ASCERTAIN THE TRUE VERTICAL AND HORIZONTAL LOCATION AND SIZE OF ALL UTILITIES, PIPES, AND/OR STRUCTURES AND SHALL BE RESPONSIBLE FOR DAMAGE TO ANY PUBLIC OR PRIVATE UTILITIES, SHOWN OR NOT SHOWN HEREON.

IMPORTANT NOTICE Section 4216 of the Government Code requires a Dig Alert Identification Number be issued before a "Permit to Excavate" will be valid For your Dig Alert I.D. Number cal Underground Service Alert wo working days before you dig

THIS PLAN IS: (NOT FOR CONSTRUCTION)

SOILS ENGINEER

THESE PLANS HAVE BEEN DESIGNED IN ACCORDANCE WITH THE GEOTECHNICAL RECOMMENDATIONS MADE BY: GILES ENGINEERING ASSOCIATES, INC.

733 W. TAFT AVENUE ORANGE, CA 92865 PH (714) 279-0817 FAX (714) 279-9687 PROJECT No. 2G-2304002 REPORT DATE: JUNE 21, 2023

CONTRACTOR SHALL OBTAIN A COPY OF THIS REPORT AND ALL ADDENDUM AND FOLLOW THE RECOMMENDATIONS THEREIN. NOTIFY TRUXAW AND ASSOCIATES OF ANY DISCREPANCIES OR FIELD CHANGES PRIOR TO CONSTRUCTION.

SIGNATURE - SOILS ENGINEER

ARCHITECT

GPD GROUP, INC

520 SOUTH MAIN STREET, SUITE 2531 AKRON, OH. 44311 (330) 572-2100 FAX (330) 572-2101

PLAN PREPARED FOR


BLOOMIN' BRANDS INC.


2202 N. WEST SHORE BOULEVARD SUITE 500 TAMPA, FL. 33607

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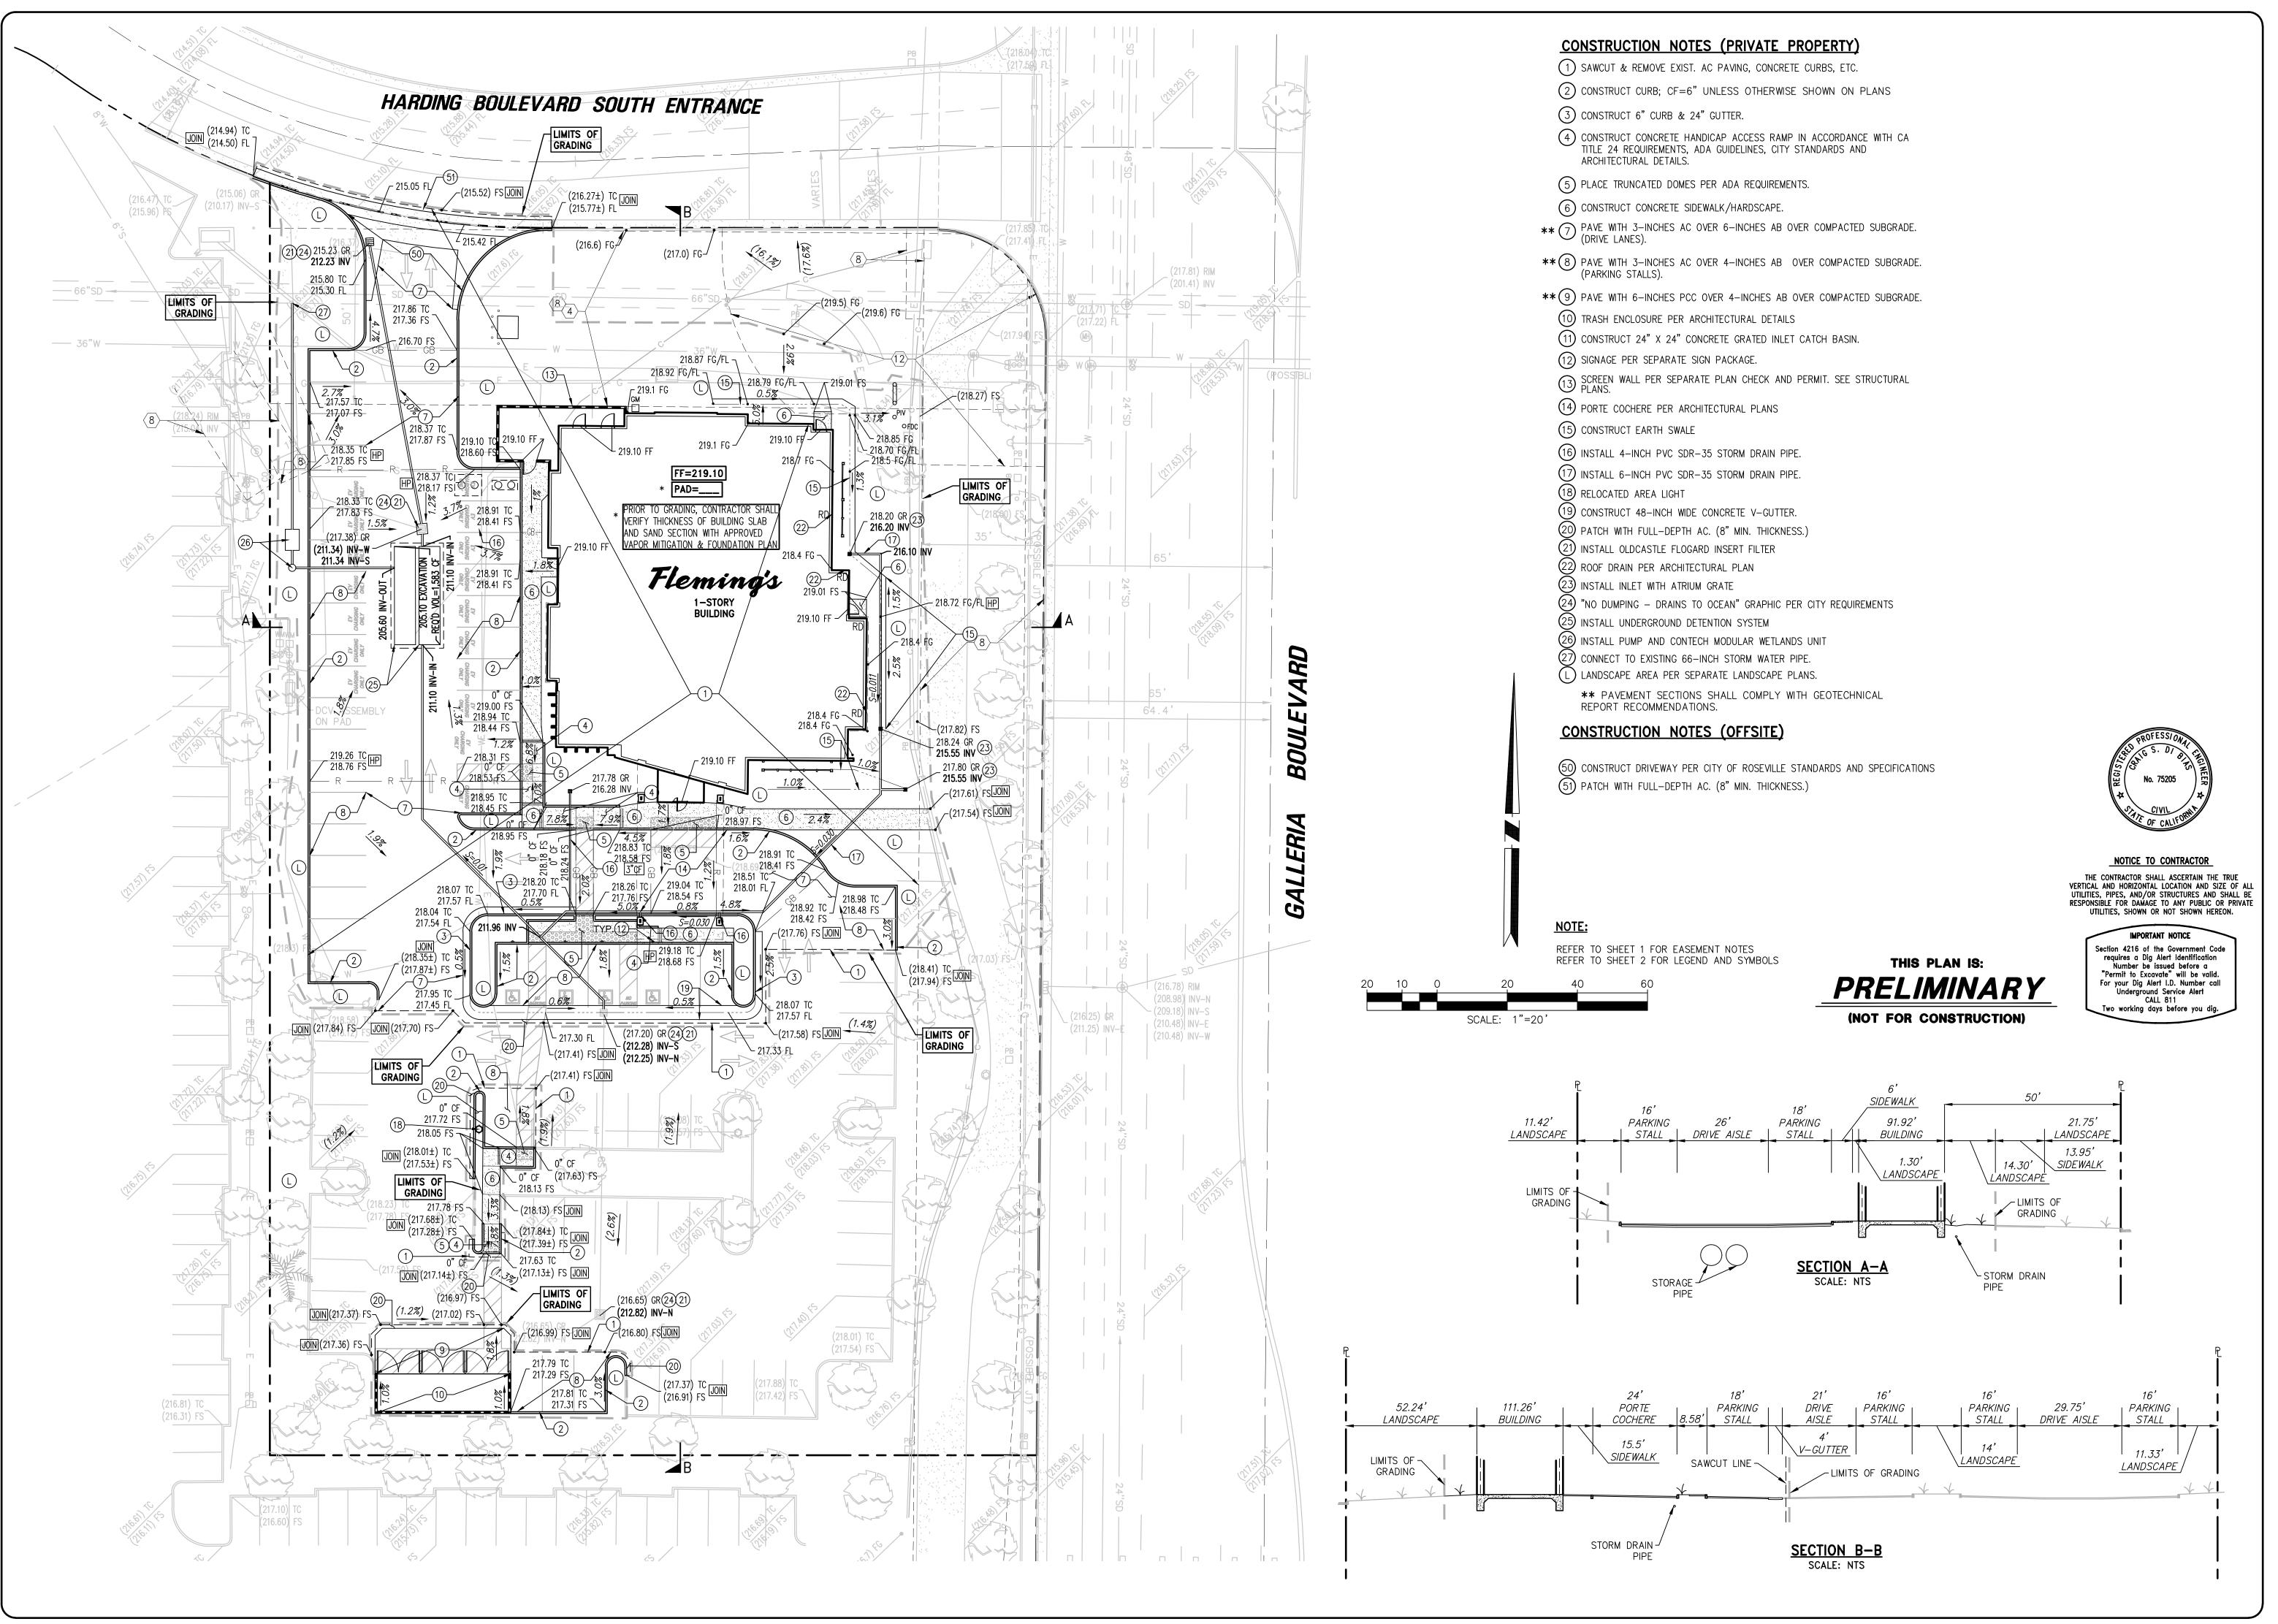


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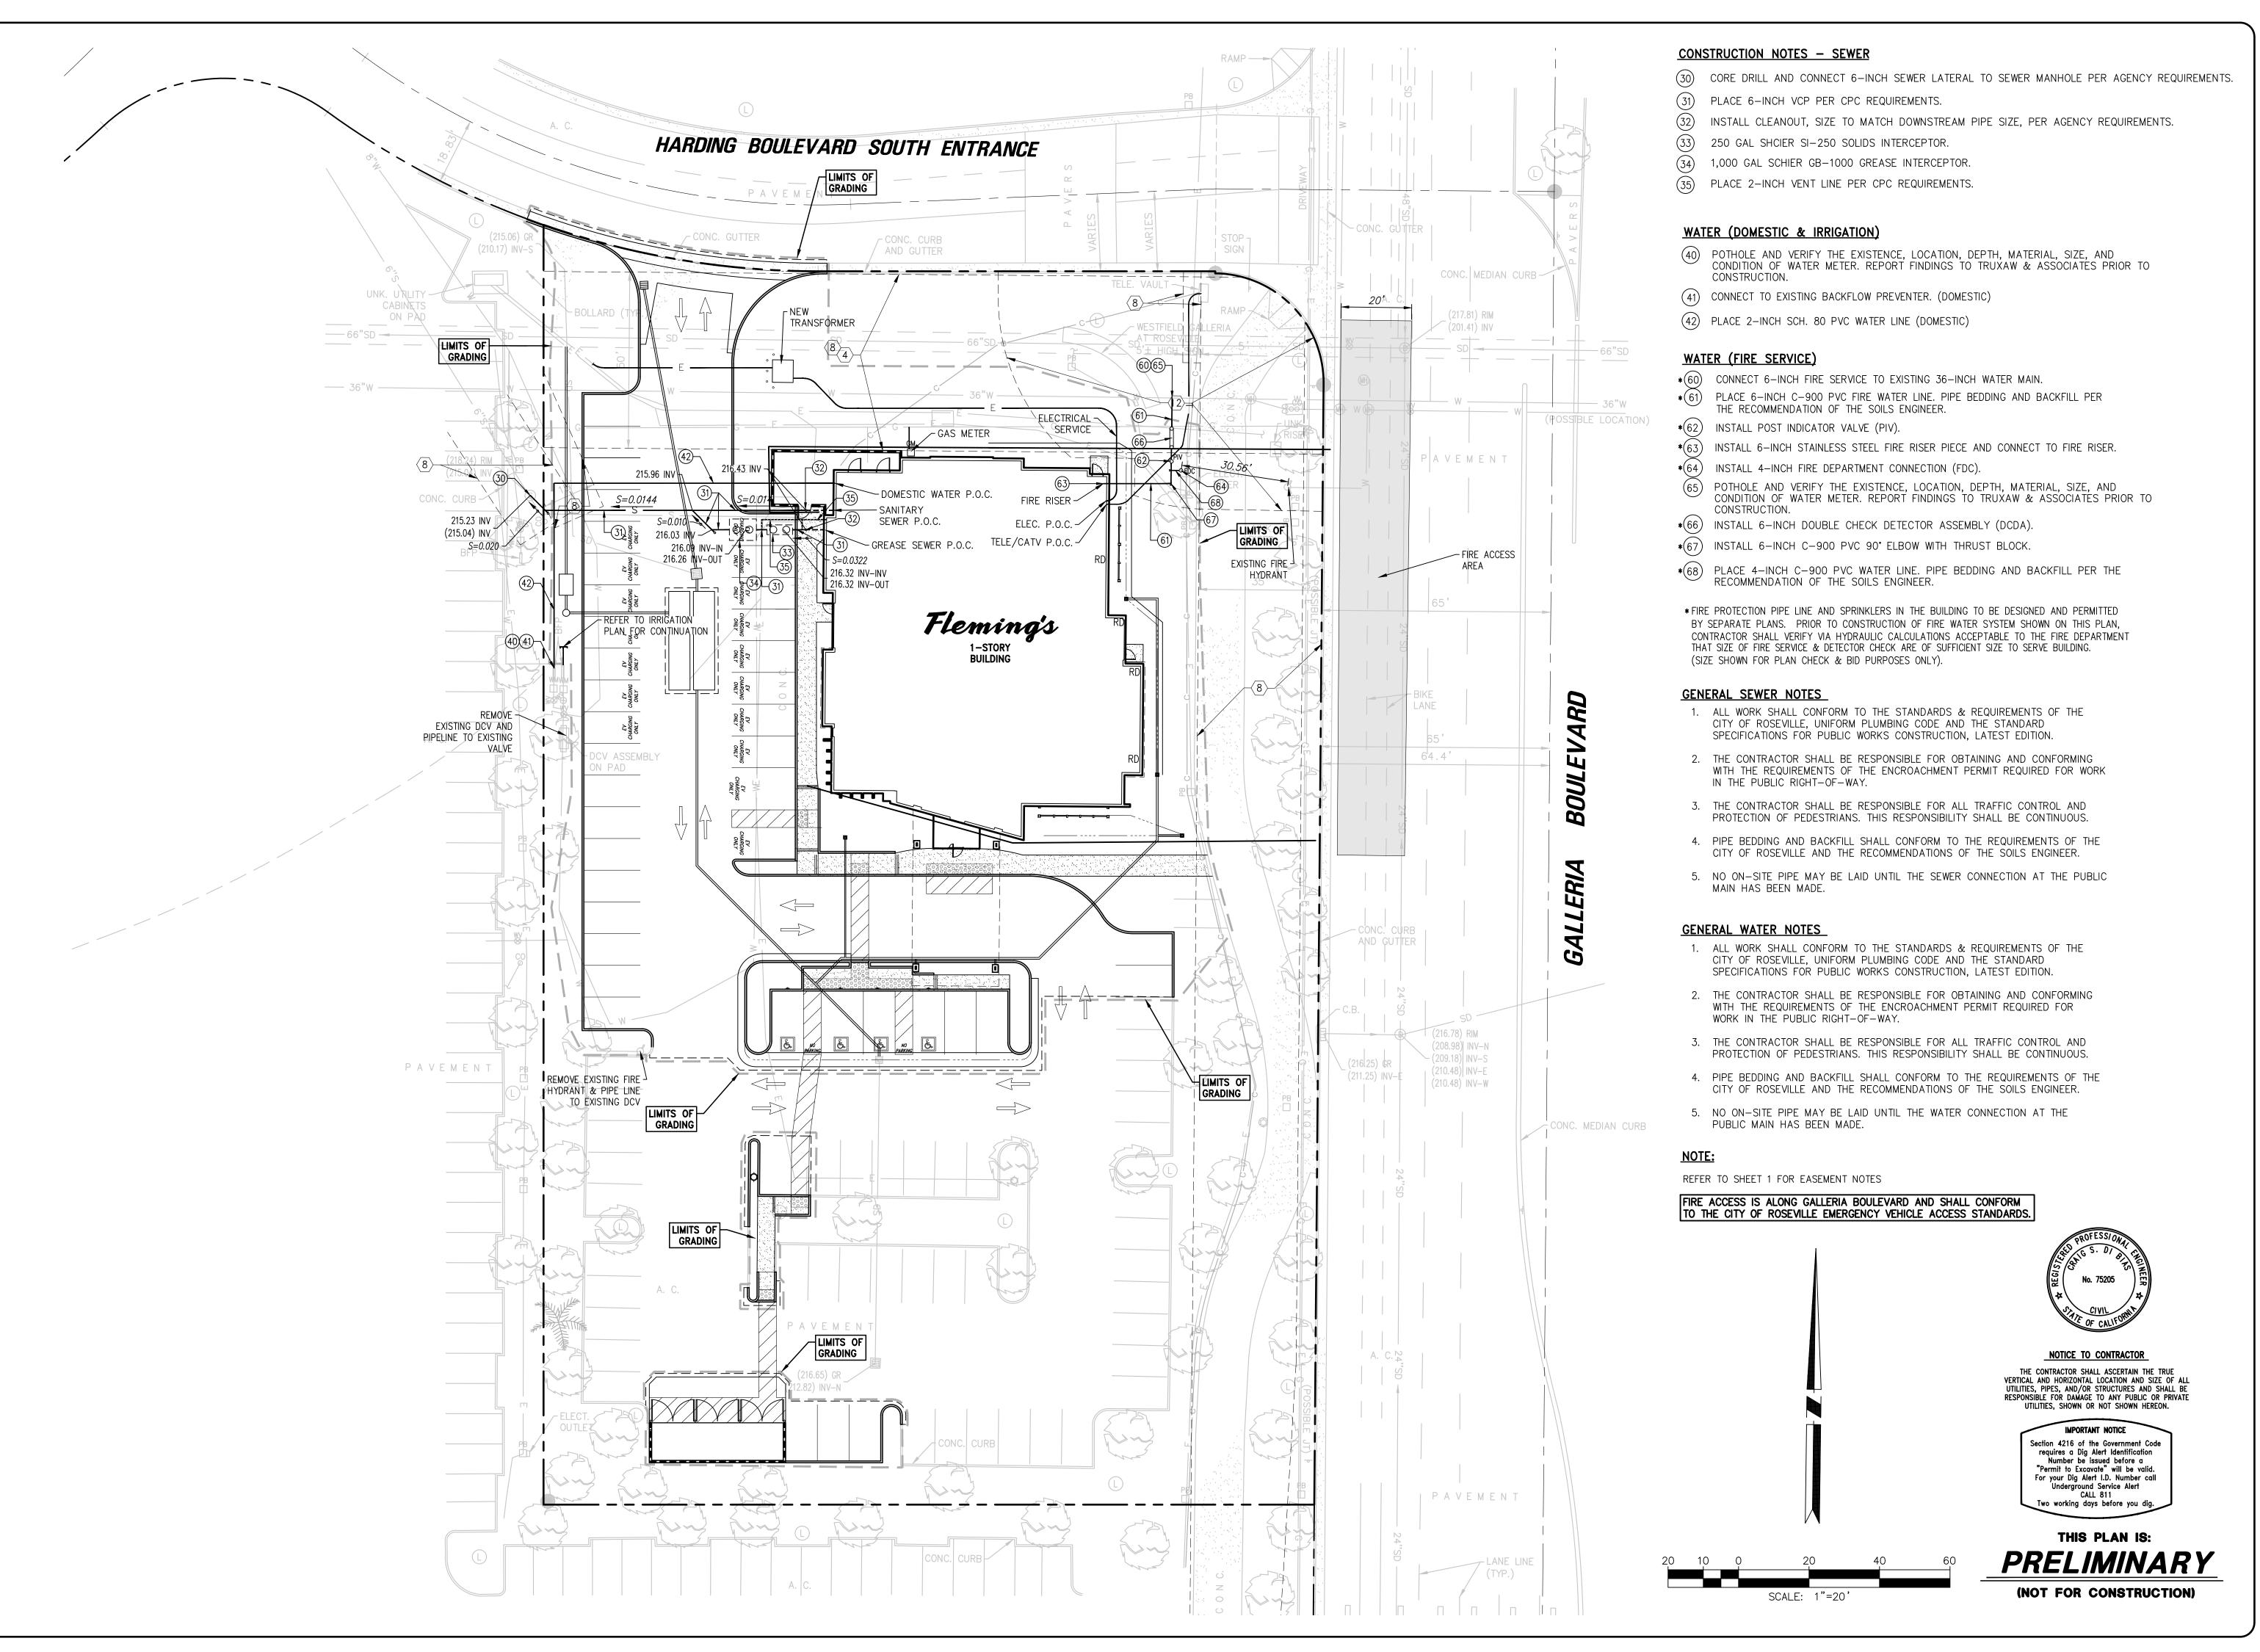


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11/14/2023 DRAWN BY TM/KSV CHECKED BY JOB NO. BLB23026

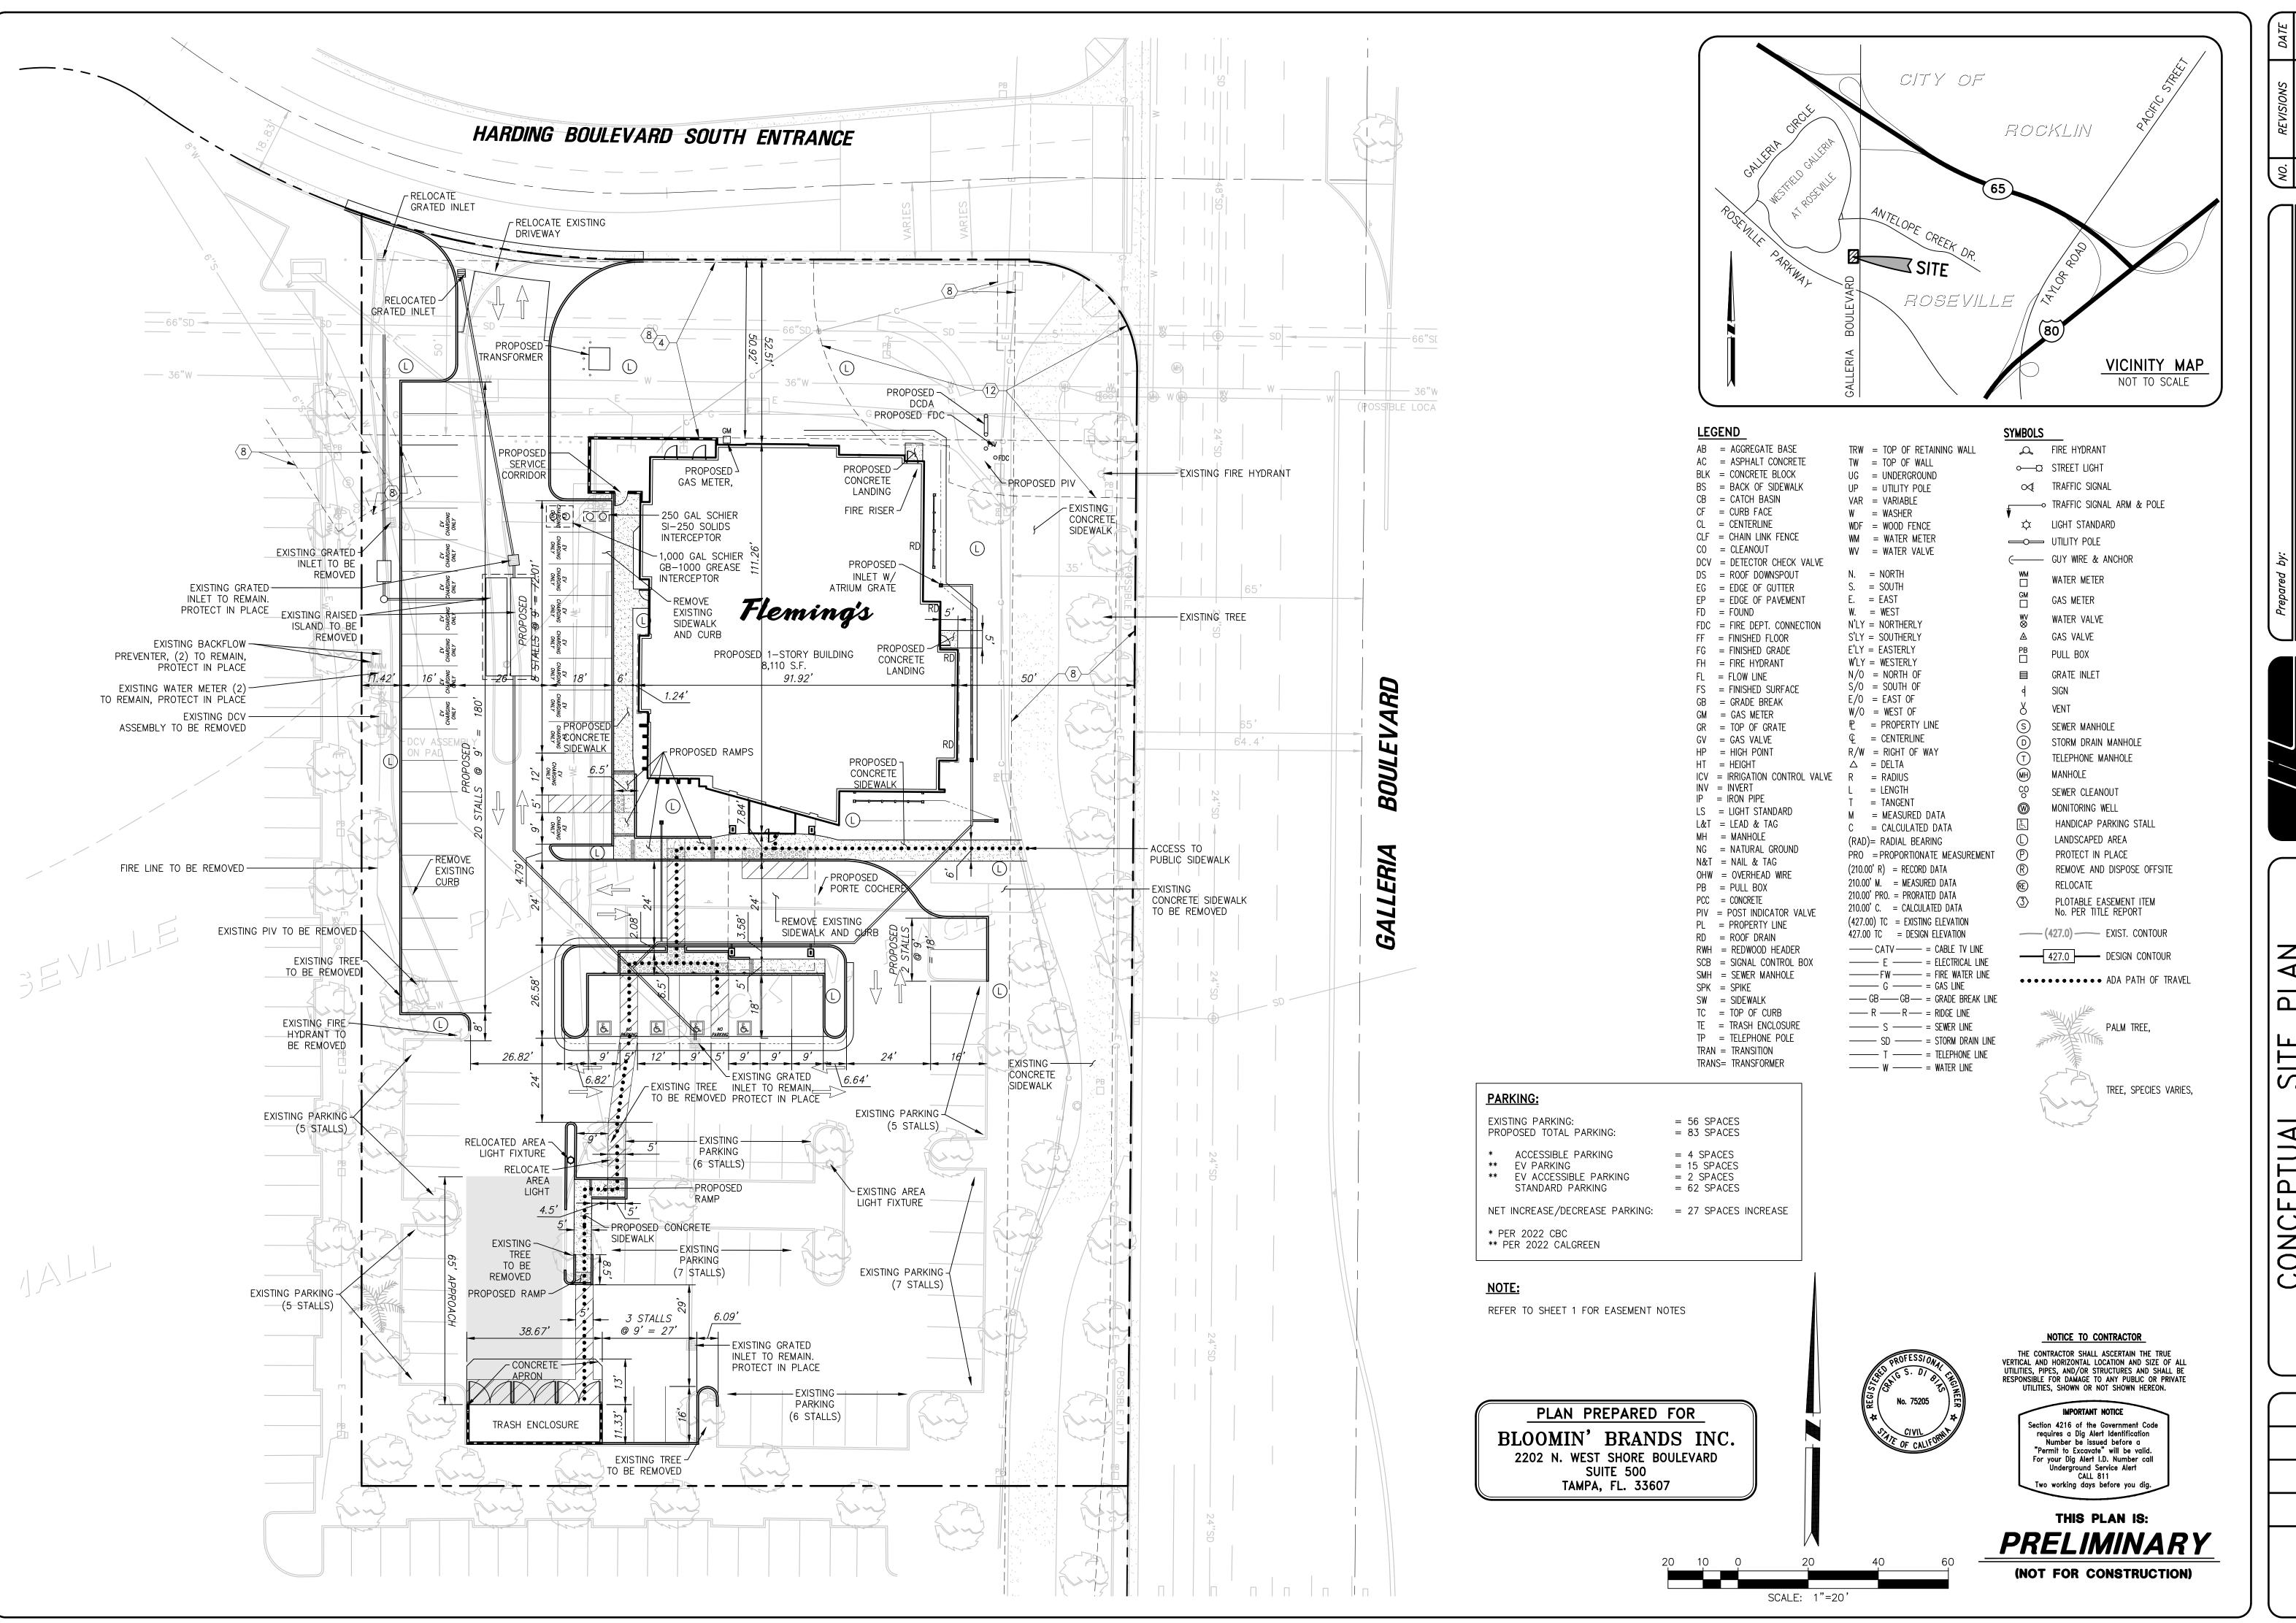SHEET NO.

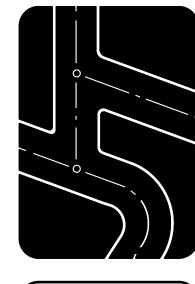

REVISIONS DATE

tes, Inc.—

xaw and Associate Land Surveyors

-Joseph C. Truxa
Civil Engineers and La

FILITY PLAN

IIO GALLERIA BOULEVARD
ROSEVILIE CALIFORNIA 95678

DATE
11/14/2023

DRAWN BY
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4 SUFETS

TITLE REPORT

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FIRST AMERICAN TITLE INSURANCE COMPANY 18500 VON KARMAN AVENUE, SUITE 600 IRVINE, CA 92612 (949) 885-2488 ORDER/FILE NUMBER: NCS-1171026-SA1 DATED: MARCH 09, 2023 TITLE OFFICER: JOSEPH GAUTHIER

LEGAL DESCRIPTION

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EXCEPTING THEREFROM ALL OIL, GAS, MINERALS, HYDROCARBON AND KINDRED SUBSTANCES LYING BELOW A DEPTH OF 500 FEET AS RESERVED IN THAT CERTAIN DEED RECORDED MAY 5, 1982 IN BOOK 2497, PAGE 696 AND THAT CERTAIN DEED RECORDED JULY 24, 1972 IN BOOK 1432, AT PAGE 305, PLACER COUNTY RECORDS.

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A NON-EXCLUSIVE EASEMENT APPURTENANT TO PARCEL ONE ABOVE FOR INGRESS AND EGRESS OF PEDESTRIAN AND VEHICULAR TRAFFIC AS PROVIDED FOR IN SECTION 1 OF THE DECLARATION OF ACCESS EASEMENT AGREEMENT RECORDED NOVEMBER 17, 2000, INSTRUMENT NO. 2000-0088322, PLACER COUNTY RECORDS.

NOTE: SAID DOCUMENT ABOVE IS ALSO LISTED HEREON AS EXCEPTION DOCUMENT NO. 11. REFER TO SAID ITEM'S NOTE HEREON REGARDING DOCUMENT'S EFFECT.

APN: 363-011-016-000

EXCEPTIONS, EASEMENT AND DISPOSITION NOTES

REFER TO TITLE REPORT FOR ADDITIONAL INFORMATION AND DETAILS:

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- THE LIEN OF SPECIAL TAX ASSESSED PURSUANT TO CHAPTER 2.5 COMMENCING WITH SECTION 53311 OF THE CALIFORNIA GOVERNMENT CODE FOR COMMUNITY FACILITIES DISTRICT 1, AS DISCLOSED BY NOTICE OF SPECIAL TAX LIEN RECORDED DECEMBER 26, 1990 AS INSTRUMENT NO. 1990-082362 OF OFFICIAL RECORDS.
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DOCUMENT(S) DECLARING MODIFICATIONS THEREOF RECORDED JUNE 18, 1991

DOCUMENT(S) DECLARING MODIFICATIONS THEREOF RECORDED NOVEMBER 07, 1995 AS INSTRUMENT NO. 1995-059717 OF OFFICIAL RECORDS.

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- NOTE: SAID EXCEPTION DOCUMENT AFFECTS THE SURVEYED LAND AND IS PLOTTED HEREON. REFER TO SAID TRACT MAP FOR FULL PARTICULARS.
- THE TERMS, PROVISIONS AND EASEMENT(S) CONTAINED IN THE DOCUMENT ENTITLED "UTILITIES EASEMENT AGREEMENT" RECORDED JANUARY 21, 2000 AS INSTRUMENT NO. 2000-0004124 OF OFFICIAL RECORDS.
- NOTE: SAID EXCEPTION DOCUMENT AFFECTS THE SURVEYED LAND WITH ITEMS PERTAINING TO THE DEVELOPMENT OF A SHOPPING CENTER AND IS BLANKET IN NATURE WITH NO PLOTTABLE MATTERS OF RECORD. REFER TO SAID DOCUMENT FOR FULL PARTICULARS.
- 10 THE TERMS AND PROVISIONS CONTAINED IN THE DOCUMENT ENTITLED 'DECLARATION OF RESTRICTIONS AND AGREEMENT" RECORDED JANUARY 21. 2000 AS INSTRUMENT NO. 2000-0004127 OF OFFICIAL RECORDS.
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THE ABOVE DOCUMENT WAS RE-RECORDED NOVEMBER 09, 2001 IN/AS INSTRUMENT NO. 2001-0118246 OF OFFICIAL RECORDS.

NOTE: SAID EXCEPTION DOCUMENT AFFECTS THE SURVEYED LAND AND IS PLOTTED HEREON. REFER TO SAID DOCUMENT FOR FULL PARTICULARS.

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NOTE: SAID EXCEPTION DOCUMENT AFFECTS THE SURVEYED LAND, IS NOT A SURVEY ITEM WITH NO PLOTTABLE MATTERS. REFER TO SAID DOCUMENT FOR FULL PARTICULARS.

14 TERMS AND PROVISIONS OF AN UNRECORDED LEASE DATED SEPTEMBER 01, 2000, BY AND BETWEEN BR OF WISCONSIN 27, LLC, A WISCONSIN LIMITED LIABILITY COMPANY AS LESSOR AND PIER 1 IMPORTS (U.S.), INC., A DELAWARE CORPORATION AS LESSEE, AS DISCLOSED BY A MEMORANDUM OF LEASE RECORDED OCTOBER 30, 2000 AS INSTRUMENT NO. 2000-0081635 OF OFFICIAL RECORDS.

DEFECTS, LIENS, ENCUMBRANCES OR OTHER MATTERS AFFECTING THE LEASEHOLD ESTATE, WHETHER OR NOT SHOWN BY THE PUBLIC RECORDS ARE NOT SHOWN HEREIN.

NOTE: SAID EXCEPTION DOCUMENT AFFECTS THE SURVEYED LAND. IS NOT A SURVEY ITEM WITH NO PLOTTABLE MATTERS. REFER TO SAID DOCUMENT FOR FULL PARTICULARS. * 15 A DEED OF TRUST TO SECURE AN ORIGINAL INDEBTEDNESS OF \$1,700,000.00 RECORDED SEPTEMBER 2, 2011 AS INSTRUMENT NO. 2011-0068544 OF OFFICIAL RECORDS.

> DATED: AUGUST 24, 2011

> > GALLERIA BOULEVARD LLC, A CALIFORNIA LIMITED LIABILITY COMPANY

TRUSTEE: FIRST AMERICAN TITLE INSURANCE COMPANY, A CORPORATION BENEFICIARY: SYMETRA LIFE INSURANCE COMPANY, A WASHINGTON

CORPORATION

TRUSTOR:

A DOCUMENT ENTITLED "ASSIGNMENT OF LEASES AND RENTS" RECORDED SEPTEMBER 2, 2011 AS INSTRUMENT NO. 2011-0068545 OF OFFICIAL RECORDS, AS ADDITIONAL SECURITY FOR THE PAYMENT OF THE INDEBTEDNESS SECURED BY THE DEED OF TRUST.

THE EFFECT OF A DOCUMENT ENTITLED "RELEASE (ASSIGNMENT OF RENTS)", RECORDED JULY 8, 2021 AS INSTRUMENT NO. 2021-0087352-00 OF OFFICIAL RECORDS.

THE EFFECT OF A DOCUMENT ENTITLED "FULL RECONVEYANCE (DEED OF TRUST)", RECORDED JULY 8, 2021 AS INSTRUMENT NO. 2021-0087355-00 OF OFFICIAL RECORDS.

NOTE: THE COMPANY WILL REQUIRE SATISFACTORY PROOF OF FULL PAYMENT OF THE DEBT SECURED BY SAID MORTGAGE OR DEED OF TRUST PRIOR TO REMOVING THIS EXCEPTION OR INSURING THE CONTEMPLATED TRANSACTION.

- AN ALTA/NSPS SURVEY OF RECENT DATE WHICH COMPLIES WITH THE CURRENT MINIMUM STANDARD DETAIL REQUIREMENTS FOR ALTA/NSPS LAND TITLE SURVEYS.
- 17 WATER RIGHTS, CLAIMS OR TITLE TO WATER, WHETHER OR NOT SHOWN BY THE PUBLIC RECORDS.
- ANY FACTS, RIGHTS, INTERESTS OR CLAIMS WHICH WOULD BE DISCLOSED BY A CORRECT ALTA/NSPS SURVEY.
- 19 RIGHTS OF PARTIES IN POSSESSION.
- * = SAID EXCEPTION DOCUMENT IS NOT A SURVEY ITEM WITH NO PLOTTABLE MATTERS. REFER TO SAID DOCUMENT FOR FULL PARTICULARS.

BENCHMARK

CITY OF ROSEVILLE BENCHMARK 47

3-1/4" BRASS DISK STAMPED 2018 PLS 8278, TOP OF CURB WEST SIDE OF D.I. ON SOUTH SIDE OF ROSEVILLE PARKWAY, APPROX. 270' + EAST OF THE SOUTH INTERSECTION OF GIBSON


ELEVATION: 173.650 FEET (NAVD88)

BASIS OF BEARINGS

THE BEARING OF NORTH 0016'08" WEST ALONG THE CENTERLINE OF HARDING BOULEVARD PER FINAL MAP OF THE GALLERIA AT ROSEVILLE REGIONAL MALL, FILED IN BOOK W, PAGE 2 OF MAPS, IN THE CITY OF ROSEVILLE, COUNTY OF PLACER, STATE OF CALIFORNIA, WAS USED AS THE BASIS OF BEARINGS FOR THIS SURVEY.

RECORD REFERENCES

(R) = FINAL MAP OF THE GALLERIA AT ROSEVILLE REGIONAL MALL, BOOK W OF MAPS, PAGE 2

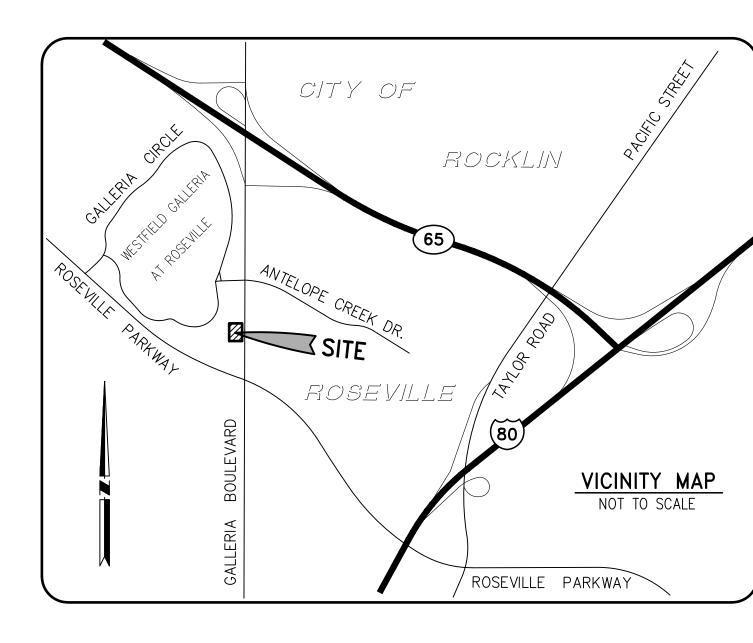

ON-SITE UTILITY PLOTTING

PORTION OF DATA SHOWN HEREON IS PLOTTED PER "C BELOW SUBSURFACE IMAGING" PLAN DATED 06/22/2023, PROJECT NO. 23-6982.

SITE AREA

SUBJECT PARCEL "A" SHOWN PER TITLE REPORT DESCRIPTION CONTAINS APPROXIMATELY: 77,145 SQ. FT. OR 1.77 ACRES

SURVEYOR'S NOTES

MICHAEL P. HERNANDEZ

PROFESSIONAL LAND SURVEYOR NO. 9281

- 1. IT IS NOT WITHIN THE PURVIEW OF THIS SURVEYOR TO MAKE DETERMINATIONS OF OWNERSHIP. AS TO "ENCROACHMENTS" SPECIFICALLY, NO INFERENCE TO SUCH DETERMINATION IS INTENDED OR IMPLIED.
- 2. LOCATIONS OF UNDERGROUND UTILITIES / STRUCTURES MAY VARY FROM LOCATIONS SHOWN HEREON. ADDITIONAL BURIED UTILITIES / STRUCTURES MAY EXIST. NO EXCAVATIONS WERE MADE DURING THE PROGRESS OF THIS SURVEY TO LOCATE BURIED UTILITIES / STRUCTURES. THE LOCATIONS OF UNDERGROUND FEATURES SHOWN HEREON ARE PLOTTED FROM AVAILABLE RECORD INFORMATION AND VISIBLE SURFACE INDICATIONS. BEFORE ANY EXCAVATIONS ARE PERFORMED, UTILITY PURVEYORS SHOULD BE CONTACTED FOR VERIFICATION OF UTILITY TYPE AND FIELD LOCATIONS.

THIS SURVEY WAS MADE BY ME OR UNDER MY DIRECTION.

THE FIELD WORK WAS COMPLETED ON MAY 25, 2023

06/28/2023 DATE

PLAN PREPARED FOR BLOOMIN' BRANDS INC.

2202 N. WEST SHORE BOULEVARD SUITE 500 TAMPA, FL. 33607

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ROSEVILLE 0 'ARD BOUL GALLERI

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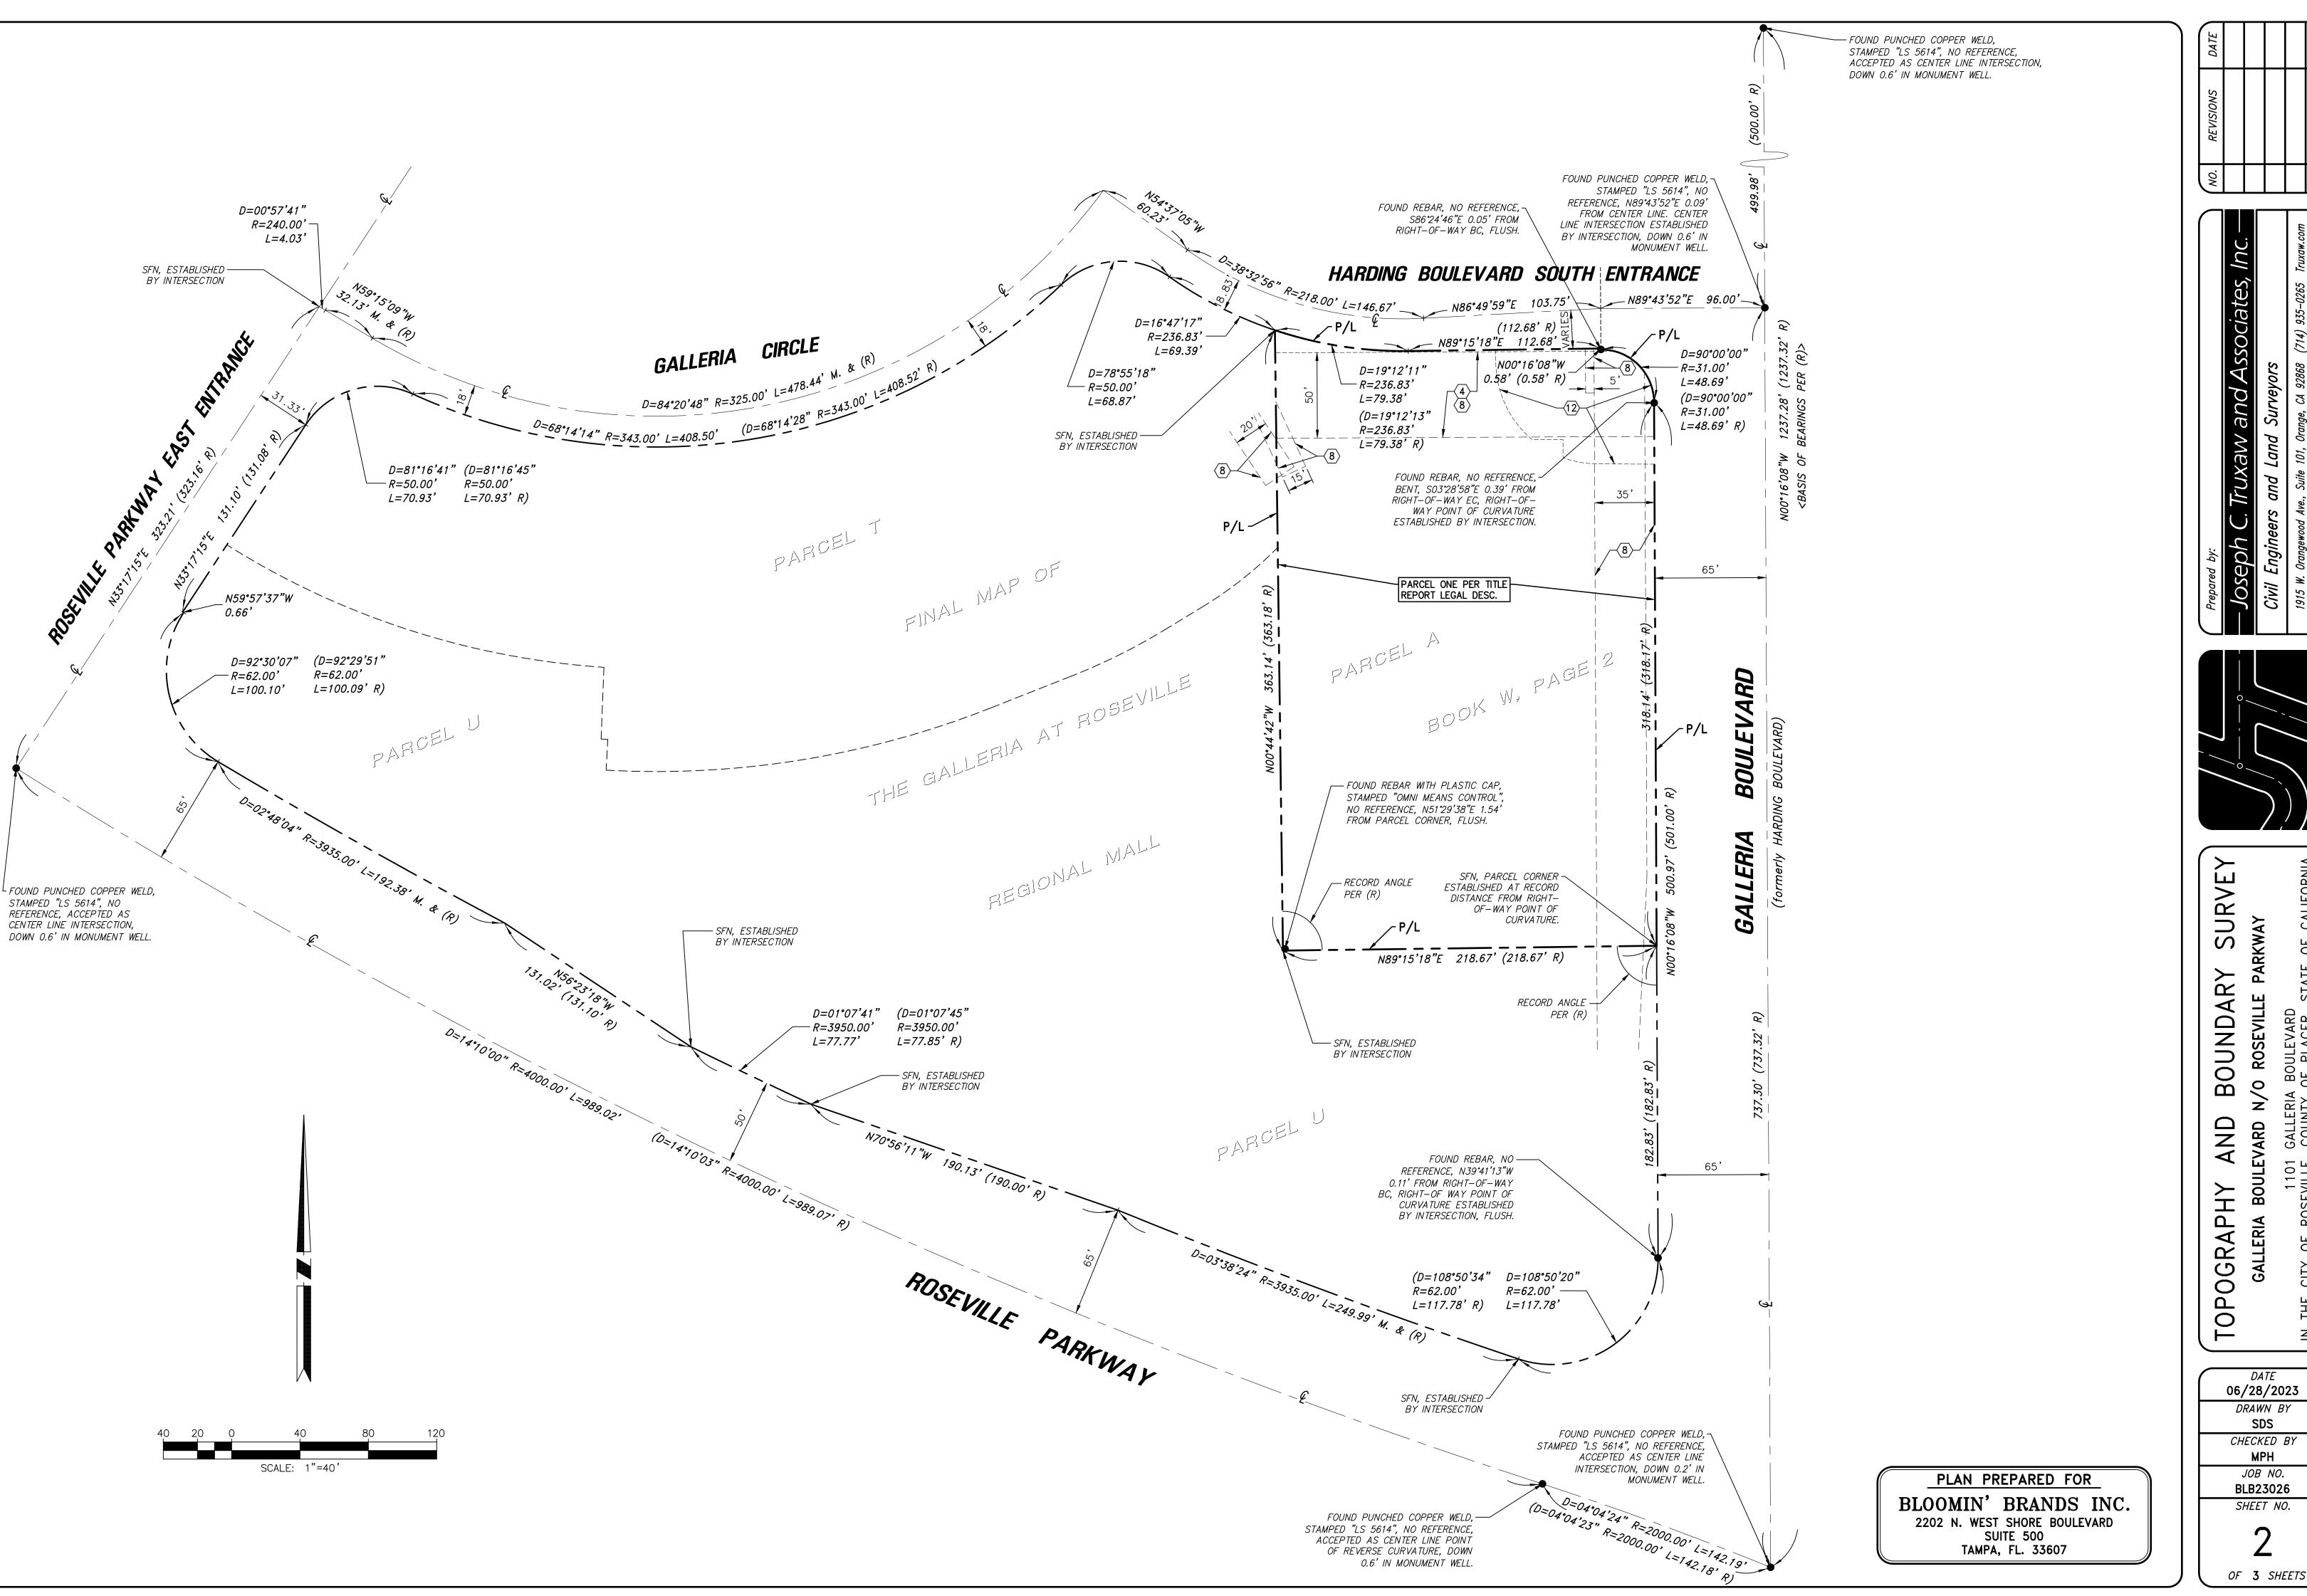
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DATE 06/28/2023 DRAWN BY

CHECKED BY

JOB NO. BLB23026 SHEET NO.




ROSEVILLE


Ó BOULEVARD GALLERIA

DATE 06/28/2023 DRAWN BY

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PLANTING NOTES

REMOVE
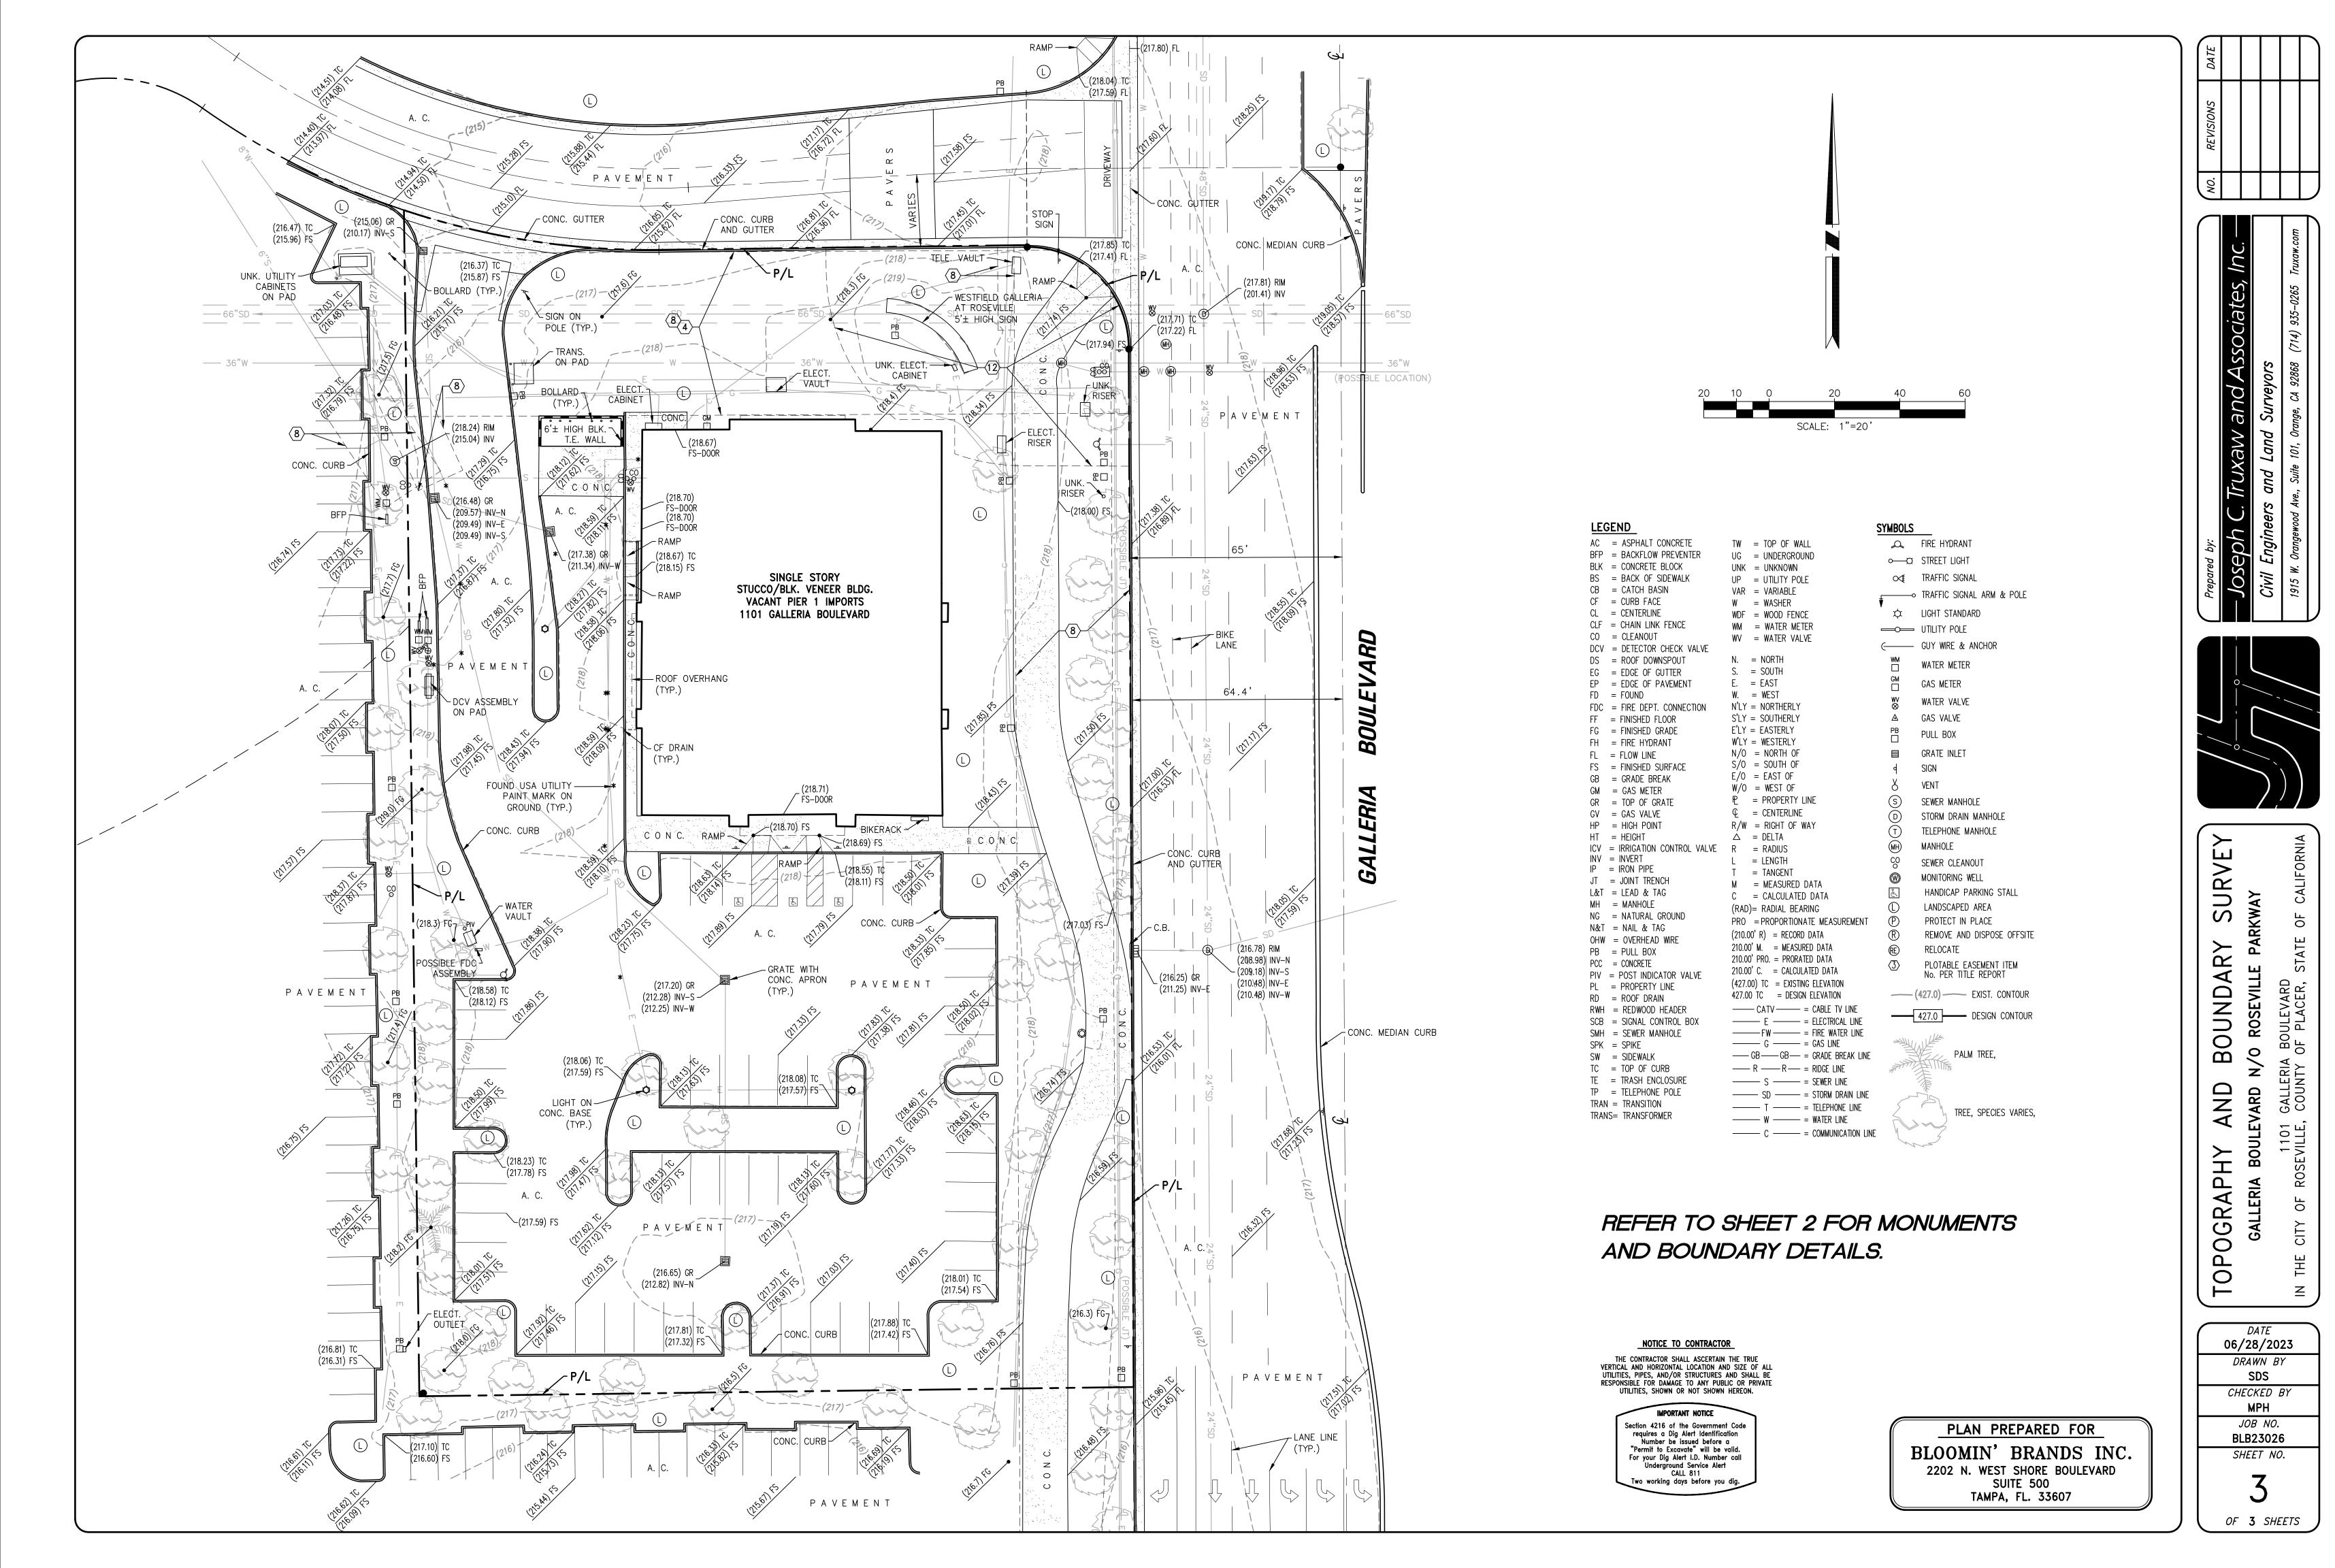
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COMMON NAME

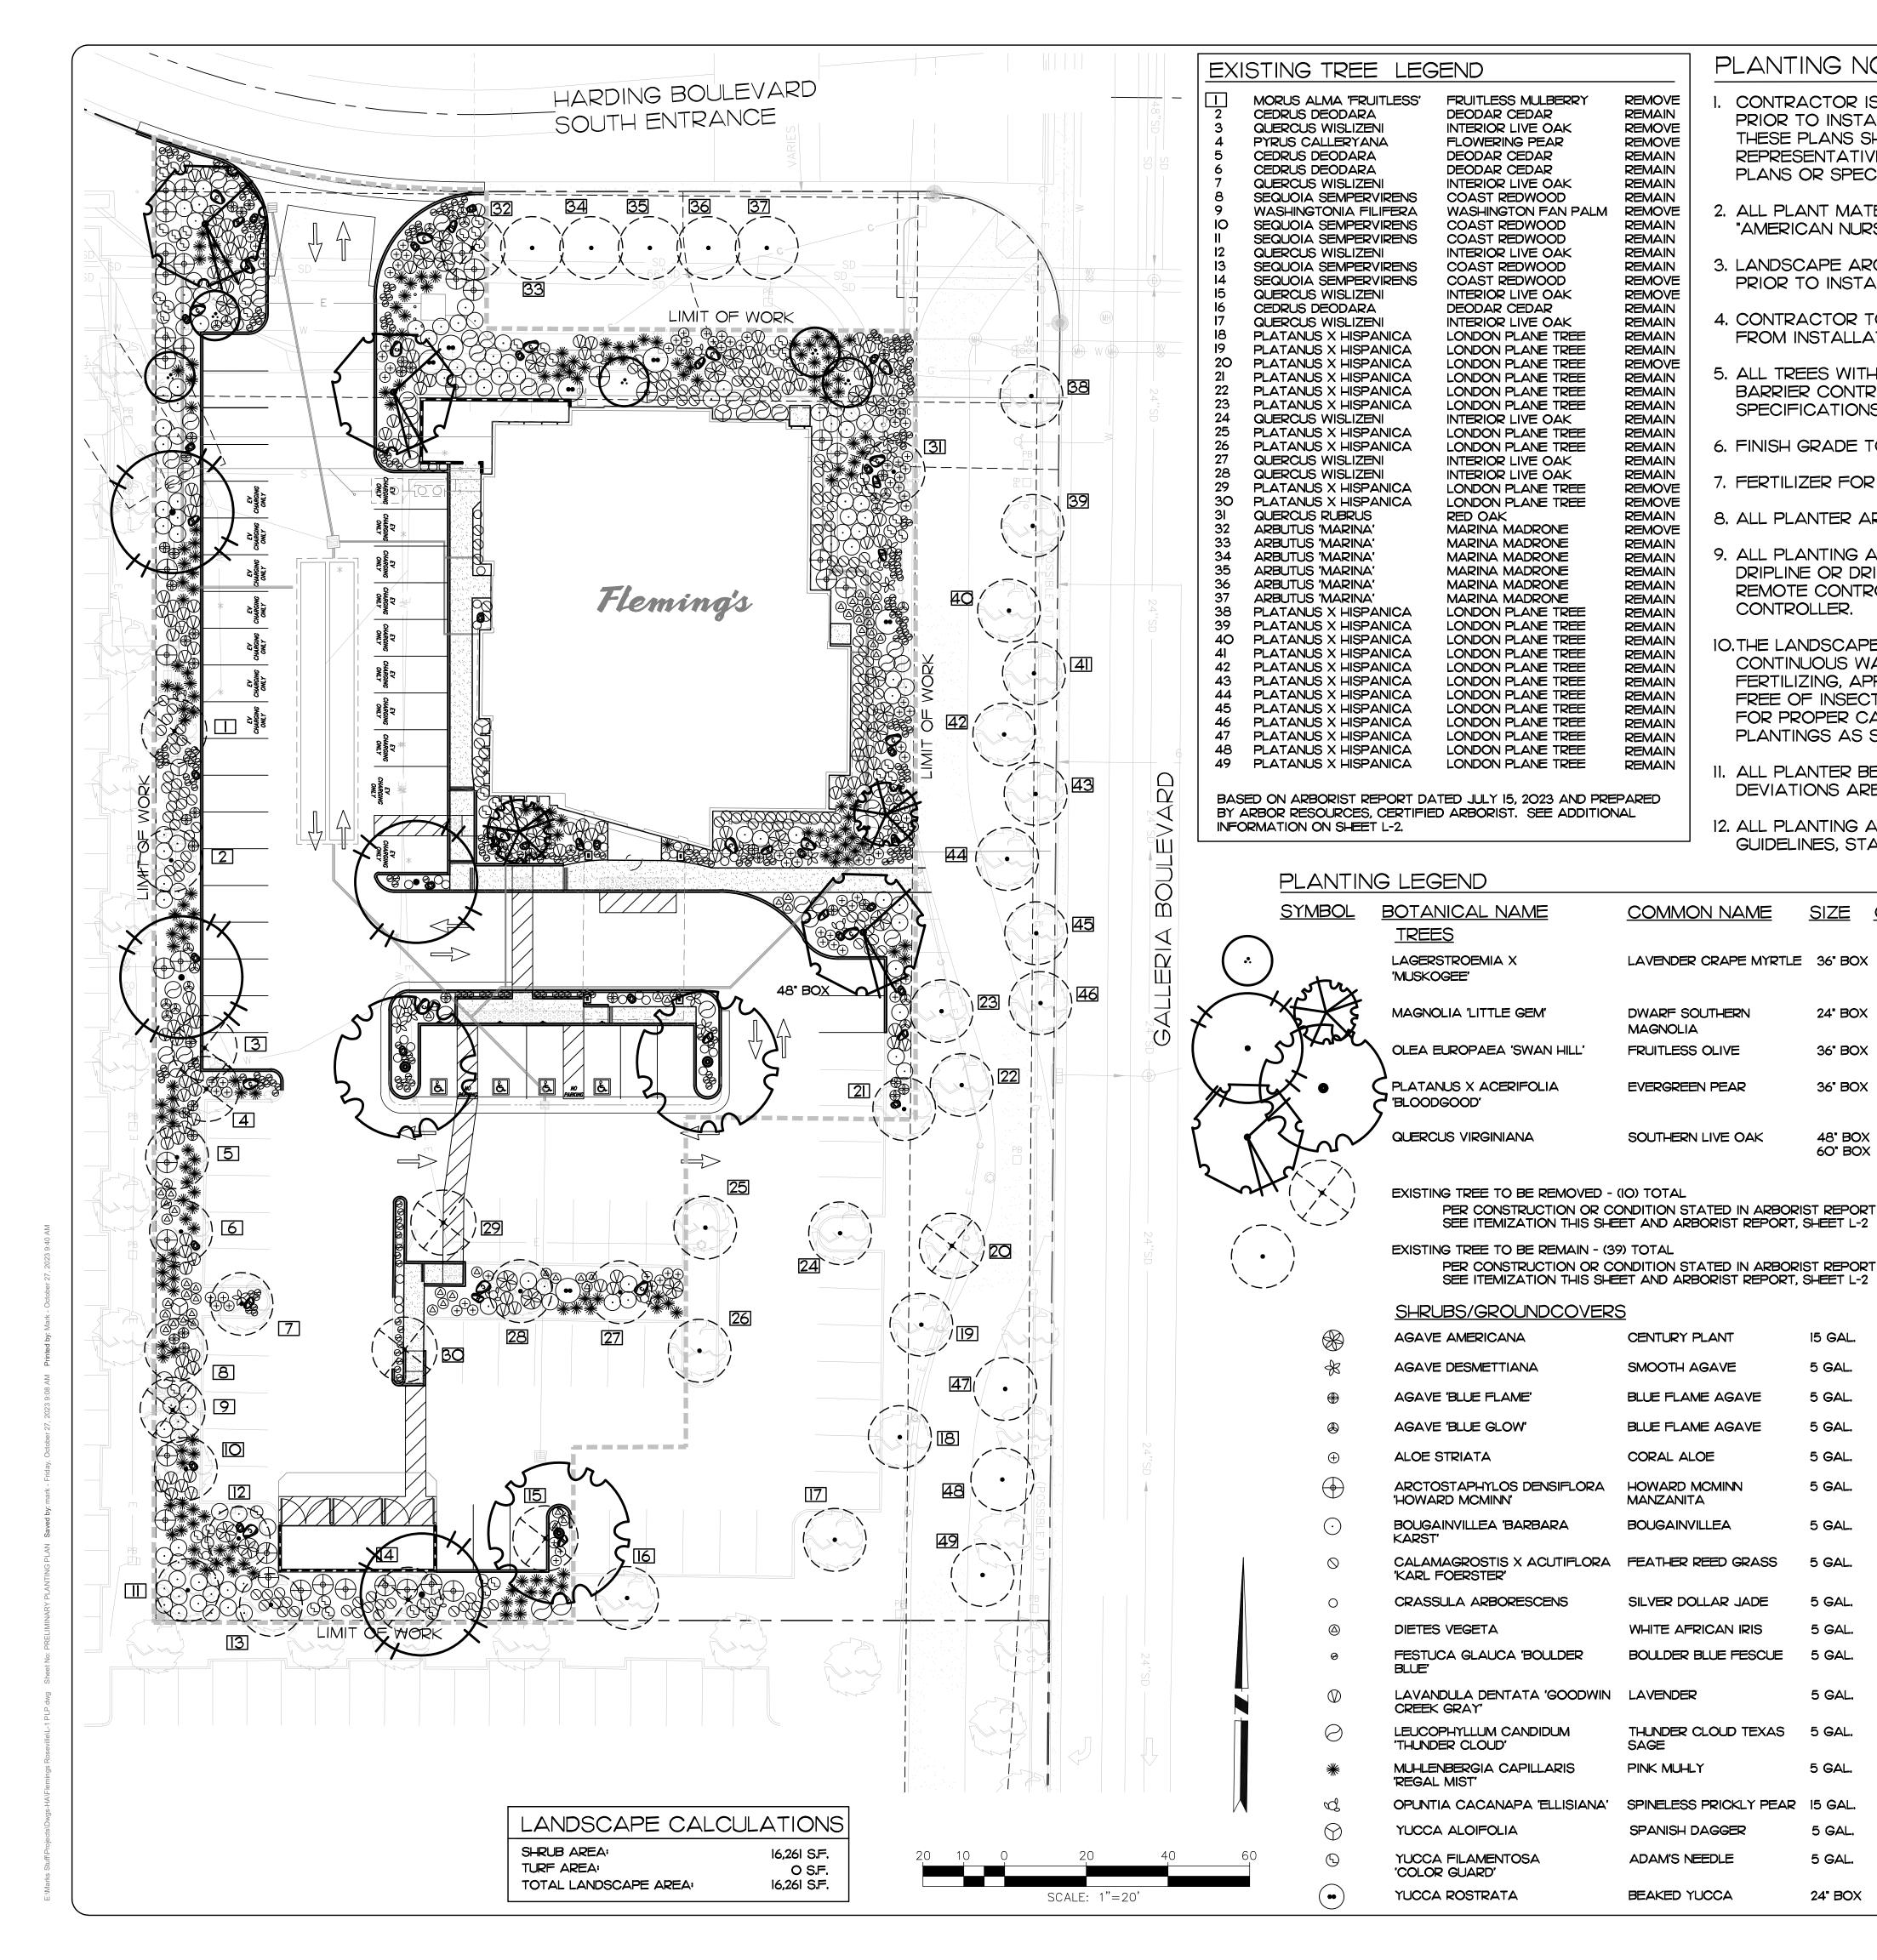DWARF SOUTHERN

FRUITLESS OLIVE

EVERGREEN PEAR

SOUTHERN LIVE OAK

CENTURY PLANT

SMOOTH AGAVE

CORAL ALOE

MANZANITA

HOWARD MCMINN

BOUGAINVILLEA

SILVER DOLLAR JADE

WHITE AFRICAN IRIS

BOULDER BLUE FESCUE

THUNDER CLOUD TEXAS

SPINELESS PRICKLY PEAR 15 GAL.

SAGE

PINK MUHLY

SPANISH DAGGER

ADAM'S NEEDLE

BEAKED YUCCA

BLUE FLAME AGAVE

BLUE FLAME AGAVE

MAGNOLIA

LAVENDER CRAPE MYRTLE 36" BOX 5

SIZE

36" BOX 4

36" BOX 3

60" BOX

- CONTRACTOR IS TO REVIEW PLANS, VERIFY SITE CONDITIONS AND PLANT QUANTITIES PRIOR TO INSTALLATION. CONFLICTS BETWEEN THE SITE AND THESE PLANS OR WITHIN THESE PLANS SHALL BE BROUGHT TO THE ATTENTION OF THE OWNER'S AUTHORIZED REPRESENTATIVE PRIOR TO LANDSCAPE INSTALLATION. ANY DEVIATION(S) FROM THE PLANS OR SPECIFICATIONS IS TO HAVE WRITTEN APPROVAL
- ALL PLANT MATERIAL SHALL BE IN ACCORDANCE WITH THE LATEST EDITION OF "AMERICAN NURSERY AND LANDSCAPE ASSOCIATION" STANDARDS. WWW.ANLA.ORG
- 3. LANDSCAPE ARCHITECT SHALL APPROVE PLANT MATERIAL PLACEMENT BY CONTRACTOR PRIOR TO INSTALLATION.
- 4. CONTRACTOR TO INCLUDE IN HIS BID THE REPAIR OF ANY AND ALL DAMAGE RESULTING FROM INSTALLATION OF PLANTING ITEMS. CONNECT TO EXISTING CONDITIONS.
- 5. ALL TREES WITHIN 8' OF WALLS, PAVING, CURBS, ETC. TO BE PROVIDED WITH ROOT BARRIER CONTROL DEVICES BY DEEP ROOT OR EQUAL PER MANUFACTURER'S SPECIFICATIONS. DO NOT WRAP ROOTBALL
- 6. FINISH GRADE TO BE 2" BELOW TOP OF CURB OR SIDEWALK FOR PLANTING AREAS.
- FERTILIZER FOR ALL PLANTING AREAS SHALL BE AS SPECIFIED WITHIN THE SOILS REPORT.
- 8. ALL PLANTER AREAS SHALL BE TOP DRESSED WITH 2" MINIMUM ROCK MULCH COVER.
- 9. ALL PLANTING AREAS SHALL BE IRRIGATED WITH SUB-GRADE BUBBLERS FOR TREES AND DRIPLINE OR DRIP EMITTERS FOR SHRUBS/GROUND COVERS. CONNECTED TO AUTOMATIC REMOTE CONTROL VALVES AND TIED INTO AN AUTOMATIC IRRIGATION "SMART" CONTROLLER.
- 10. THE LANDSCAPE CONTRACTOR SHALL MAINTAIN ALL PLANTED AREAS BY MEANS OF CONTINUOUS WATERING, PRUNING, RAISING TREE BALLS WHICH SETTLE BELOW GRADE, FERTILIZING, APPLICATION OF SPRAYS WHICH ARE NECESSARY TO KEEP THE PLANTINGS FREE OF INSECTS AND DISEASES, WEEDING, AND/OR OTHER OPERATIONS NECESSARY FOR PROPER CARE AND UPKEEP. THE LANDSCAPE CONTRACTOR SHALL MAINTAIN ALL PLANTINGS AS SPECIFIED ABOVE FOR A PERIOD OF NINETY (90) DAYS.
- II. ALL PLANTER BEDS TO BE AMENDED WITH SOIL PREPARATION PER SPECIFICATIONS. NO DEVIATIONS ARE ALLOWED.

<u>WUCOLS IV</u>

MODERATE

MODERATE

MODERATE

MODERATE

LOW

REGION 4

<u>REMARKS</u>

MULIT-TRUNNK

DECIDUOUS

EVERGREEN

STANDARD

STANDARD

5'-O' O.C.

4'-0" O.C.

2'-6" O.C.

2'-6" O.C.

2'-6" O.C.

5'-O" O.C.

4'-0" O.C.

2'-6" O.C.

2'-0" O.C.

2'-0" O.C.

1'-6" O.C.

3'-0" O.C.

4'-0" O.C.

3'-O" O.C.

3'-0" O.C.

4'-0" O.C.

3'-O" O.C.

AS SHOWN

39

107

157

33

275

193

24" BOX

DECIDUOUS

48" BOX NOTED EVERGREEN

LOW BRANCHING MODERATE

EVERGREEN

12. ALL PLANTING AND IRRIGATION ON THIS PROJECT TO MEET OR EXCEED CITY LANDSCAPE GUIDELINES, STANDARDS AND AGENCY REQUIREMENTS.

PLANTING LEGEND

<u>SYMBOL</u>	<u>DESCRIPTION</u>
NO	ALL PLANTING AREAS TO RECEIVE INOR

- - ALL ROCK AND BOULDERS AVAILABLE FROM ROSEVILLE LANDSCAPE MATERIAL SUPPLY (916) 783-9177.

RGANIC ROCK MULCH MIX AS FOLLOWS: 40% I-I/2" SALT AND PEPPER ROCK 60% 3/8" SALT AND PEPPER ROCK LANDSCAPE BOULDER (SMALL 18"-24" - SONOMA GOLD 0 LANDSCAPE BOULDER (MEDIUM 24"-36" - SONOMA GOLD TOTAL OF 15 LANDSCAPE BOULDER (LARGE 36"-48" - SONOMA GOLD TOTAL OF 19

> hourian associates, landscape architecture + design san clemente | santa barbara, california



DRAWN BY CHECKED BY BLB23026 SHEET NO. ___

City of Roseville Approval

 Δ

DATE 10/27/2023

ARBORIST REPORT

FLEMING'S

WESTFIELD GALLERIA

1101 GALLERIA BLVD.

ROSEVILLE, CA

(APN 363-011-016)

Prepared for:

Hourian Associates, Inc.

414 Olive Street #227

Santa Barbara, CA 93101

Prepared by:

David L. Babby

Registered Consulting Arborist® #399

Board-Certified Master Arborist® #WE-4001B


July 15, 2023

p.o. box 25295, san mateo, california 94402 • email: arborresources@comcast.net

be from their outermost perimeter near soil grade.

5.1 Design Guidelines


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hourian associates, in landscape architecture + design san clemente | santa barbara, california o: 949.489.5623 f: 858.810.0335

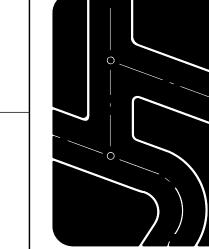



BLB23026

SHEET NO. —

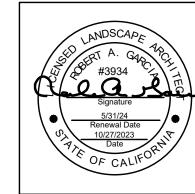July 15, 2023

2.0 TREE COUNT AND COMPOSITION

sequentially numbered as 1 thru 49, and Table 1 below identifies their common names, numbers, counts and overall percentages.

Forty-nine (49) trees of nine various species were inventoried for this report. They are

Table 1 - Tree Count and Composition

NAME	TREE NUMBER(S)	COUNT	% OF TOTAL
Coast redwood	8, 10, 11, 13, 14	5	10%
Deodar cedar	2, 5, 6, 16	4	8%
Flowering pear	4	1	2%
Fruitless mulberry	1	1	2%
Interior live oak	3, 7, 12, 15, 17, 24, 27, 28	8	16%
London plane tree	18-23, 25, 26, 29, 30, 38-43, 45-49	22	45%
Marina madrone	32-37	6	12%
Red oak	31	1	2%
Washington fan palm	9	1	2%
	1	1	1

Specific information regarding each tree is presented within the table in Exhibit A. The trees' numbers and approximate locations can be viewed on the site map in Exhibit B, and photographs are presented in Exhibit C.

Fleming's (Westfield Galleria); 1101 Galleria Blvd., Roseville Page 2 of 10 Hourian Associates, Inc.

1.0 INTRODUCTION

Fleming's Prime Steakhouse & Wine Bar is planning to construct a new restaurant at 1101 Galleria Boulevard, Roseville. The site is within the Westfield Galleria shopping center, and the existing building is vacant and will be demolished (previously occupied by Pier 1 Imports). To supplement the planning submittal, Hourian Associates has retained me to prepare this Arborist Report, and specific tasks assigned to execute are as follows:

- Visit the site on 7/10/23 to inventory and evaluate 49 trees having trunks located within the property boundary identified on the Topographic and Boundary Survey, prepared by Joseph C. Truxaw and Associates, dated 6/28/23.
- Measure each tree's trunk diameter at 54 inches above grade, or for trees with trunks or major limbs at or below 54 inches, then immediately beneath their union. All diameters are around to the nearest inch (i.e. whole number), and those listed with more than one diameter are formed by multiple trunks emerging at grade.
- Estimate each tree's height and average canopy spread (most are rounded to the
- Ascertain each tree's health, structural integrity and form, and assign an overall condition rating pursuant to Section 19.66.050 of the Roseville Municipal Code
- (these categories include: excellent, good, fair to good, fair, fair to poor, or poor). • Rate each tree's suitability for preservation (e.g. high, moderate or low).
- Obtain photographs; see Exhibit C.
- Document any observed health, structure and/or hardscape issues.
- Identify protected trees¹ and/or street trees² pursuant to Roseville's Municipal Code.
- Review an undated, *Test Fit* plan, prepared by GPD Group, to ascertain the proposed
- tree disposition and potential impacts. • Assign numbers to the trees, and plot them onto the site map in Exhibit B (base map is a copy of the above-referenced topo survey).
- Nail round silver tags with corresponding engraved numbers onto each tree (for newly installed trees #32 thru 37, tags are nailed onto a wooden support stake).
- Provide design guidelines and protection/health care measures to avoid or mitigate potential impacts to retained trees.
- Prepare this report to present the above items, and submit via email as a PDF document.

Section 19.66.020 of the Municipal Code defines a protected tree as being any native oak having a trunk diameter, either single or multiple, of ≥6 inches measured at 54 inches above grade (at the high side of tree

when measuring along a slope). Section 8.04.030(G) of the Municipal Code defines street trees as being located within a City easement. Fleming's (Westfield Galleria); 1101 Galleria Blvd., Roseville

David L. Babby, Registered Consulting Arborist®

Hourian Associates, Inc.

Information presented herein covers only inventoried trees, and reflects their size, condition,

6.0 ASSUMPTIONS AND LIMITING CONDITIONS

- and areas viewed from the ground, project site, streets and sidewalk on 7/10/23. • Observations were performed visually without probing, coring, dissecting or excavating.
- The assignment pertains solely to trees listed in Exhibit A. I hold no opinion towards other trees on or surrounding the project area.
- I cannot provide a guarantee or warranty, expressed or implied, that deficiencies or problems of any trees or property in question may not arise in the future.
- No assurance can be offered that if all my recommendations and precautionary measures (verbal or in writing) are accepted and followed that the desired results may be achieved.
- I cannot guarantee or be responsible for the accuracy of information provided by others.
- I assume no responsibility for the means and methods used by any person or company implementing recommendations provided in this report.
- Information presented herein represents my opinion. Accordingly, my fee is in no way contingent upon the reporting of a specified finding, conclusion or value.
- Numbers shown on the site map in Exhibit B are solely intended to represent a tree's general location and shall not be construed as surveyed points.
- This report is proprietary to me, and may not be copied or reproduced in whole or part without prior written consent. It has been prepared for the sole and exclusive use of the parties to who submitted for the purpose of contracting services provided by David L. Babby.

Date: <u>July 15, 2023</u>

Registered Consulting Arborist® #399 Board-Certified Master Arborist® #WE-4001B CA Licensed Tree Service Contractor #796763 (C61/D49)



Fleming's (Westfield Galleria); 1101 Galleria Blvd., Roseville

Hourian Associates, Inc.

Page 10 of 10

David L. Babby, Registered Consulting Arborist®

pits beyond TPZs), tunnel using a pneumatic air device (e.g. an AirSpade®), or manually dig with a shovel (i.e. no jackhammer); these assume pipe bursting, an optimal method, does not apply to this project. For any boring, establish access pits and above-ground infrastructure (e.g. splice boxes, meters and vaults) beyond TPZs.

- 5. New irrigation and lighting features (e.g. main line, lateral lines, valve boxes, wiring, controllers and meters) should not require trenching or digging within a TPZ. If trenching inside a TPZ is necessary, route them in a radial direction to a tree's trunk, and terminate a specific distance from a trunk (versus crossing past it). Irrigation inside TPZs should consist of Netafim soaker hoses, or equivalent, laid on grade and covered by mulch. Additionally, header lines connecting hoses should terminate beyond a TPZ.

- b. Establish any bender board or other edging material within TPZs to be on top of
- c. Utilize a 2- to 3-inch layer of coarse wood chips or other high-quality mulch for new ground cover beneath canopies (avoid using gorilla hair, bark or rock, stone, gravel, black plastic or other synthetic ground cover). Do not pile mulch against
- d. Plan to provide continual irrigation, in the form of a potable source, to the TPZs
- 7. Establish the future staging area and route(s) of access beyond unpaved areas beneath or near canopies.
- 8. The erosion control design should represent silt fence and/or straw rolls at locations material should not be embedded into the ground by more than 2 inches, nor require the severance of shallow roots.
- 9. Avoid specifying the use of herbicides use within a TPZ; where used on site, they from a tree's canopy.

Hourian Associates, Inc.

FOR THE ARBORIST REPORT IN ITS ENTIRETY, REFER TO REPORT SUBMITTED BY ARBOR RESOURCES PREPARED ON JULY 15, 2023.

= TOP OF WALL
= UNDERGROUND
K = UNKNOWN
= UTILITY POLE
R = VARIABLE
= WASHER
F = WOOD FENCE
I = WATER METER
F = WATER VALVE

DE GUITER

S. = SOUTH

W. = WEST

Y. CONNECTION

R. WEST

Y. CONNECTION

R. WEST

SILY = SOUTHERLY

SILY = SOUTHERLY

SILY = SOUTHERLY

RATT

WILY = NORTHERLY

RATT

WILY = WESTERLY

N/O = WORTH of

WILY = WESTERLY

AW | WESTERLY

WILY = WESTERLY

WILY = WESTERLY

RESTOR | WESTERLY

WILY = WESTE

REFER TO SHEET 2 FOR MONUMENTS

AND BOUNDARY DETAILS.

---- TRAFFIC SIGNAL ARM & POLE

PLOTABLE EASEMENT ITEM No. PER TITLE REPORT ----- (427.0) ----- EXIST. CONTOUR

> PLAN PREPARED FOR BLOOMIN' BRANDS INC. 2202 N. WEST SHORE BOULEVARD SUITE 500 TAMPA, FL. 33607

GUY WIRE & ANCHOR

WATER METER
GAS METER
WATER VALVE
GAS VALVE
PULL BOX
GRATE INLET
SIGN

= ASPHALT CONDETE

= BASHALT CONDETE

= BASHALT ONDETE

= CONCISCE ELOCK

= BACK OF SIDEWALK

= CATCH BASIN

= CATCH BASIN

= CATCH BASIN

= CATCH BASIN

= CHARLES

= CHARLIMK FENCE

= CHARLIMK FENCE

= CLEANOUT

= COLOROUT

= ENCE OF GOINERA

= FIRE EPT. CONNECTION

= F

5.0 TREE PROTECTION MEASURES

Recommendations presented within this section serve as protection and health care

measures for trees being retained. They are subject to revision upon reviewing project

plans, and I (hereinafter "project arborist") should be consulted in the event any cannot be

feasibly implemented. Please note that all referenced distances from trunks are intended to

1. Consider each Tree Protection Zone (TPZ) as being linear distances from trunks of at least 10 times their diameters where within existing planters (e.g. a 10-inch diameter trunk would have a setback of at least 8 feet from its closest edge in all directions within existing planters). Where within their TPZs, avoid the following activities (and is not necessarily limited to): grading, trenching, soil compaction, overexcavation, subexcavation, tilling, ripping, swales, bioswales, storm drains, dissipaters, equipment cleaning, removal of underground utilities and vaults, altering existing water/drainage flows, stockpiling and dumping of materials, and equipment and vehicle operation. Where an impact encroaches slightly within a setback, it can be reviewed on a case-by-case basis by the project arborist to determine appropriate mitigation measures.

2. On all site-related plans, add a note instructing contractors to comply with recommendations provided in this report, and show trunk locations, assigned numbers, and diameters of existing trees.

3. On the demolition plan (or equivalent), reflect proposed removals by placing an "X" across their trunks, and specify that underground portions of existing and unused lines, pipes and manholes, etc. within a TPZ shall be abandoned and cut off at existing soil grade (rather than being dug up and causing root damage).

4. Route all underground utilities beyond TPZs. Where not feasible, consider the following alternative trenching or installation methods (listed in order of least to most impactful): directionally bore by at least 3.5 feet below grade (and establish access

Fleming's (Westfield Galleria); 1101 Galleria Blvd., Roseville Page 6 of 10 Hourian Associates, Inc.

10/27/2023

OF 4 SHEETS City of Roseville Approval

6. Adhere to the following additional landscape guidelines: a. Avoid tilling, ripping and compaction within TPZs.

existing soil grade (such as by using vertical stakes).

trunk, rather taper the depth to 1/2- or 1/4-inch at the trunk.


of the redwoods.

beyond TPZs, and at a minimum, not against a tree's trunk. Where within a TPZ, the

should be labeled for safe use near trees. Also, liming shall not occur within 50 feet

Fleming's (Westfield Galleria); 1101 Galleria Blvd., Roseville

Page 7 of 10

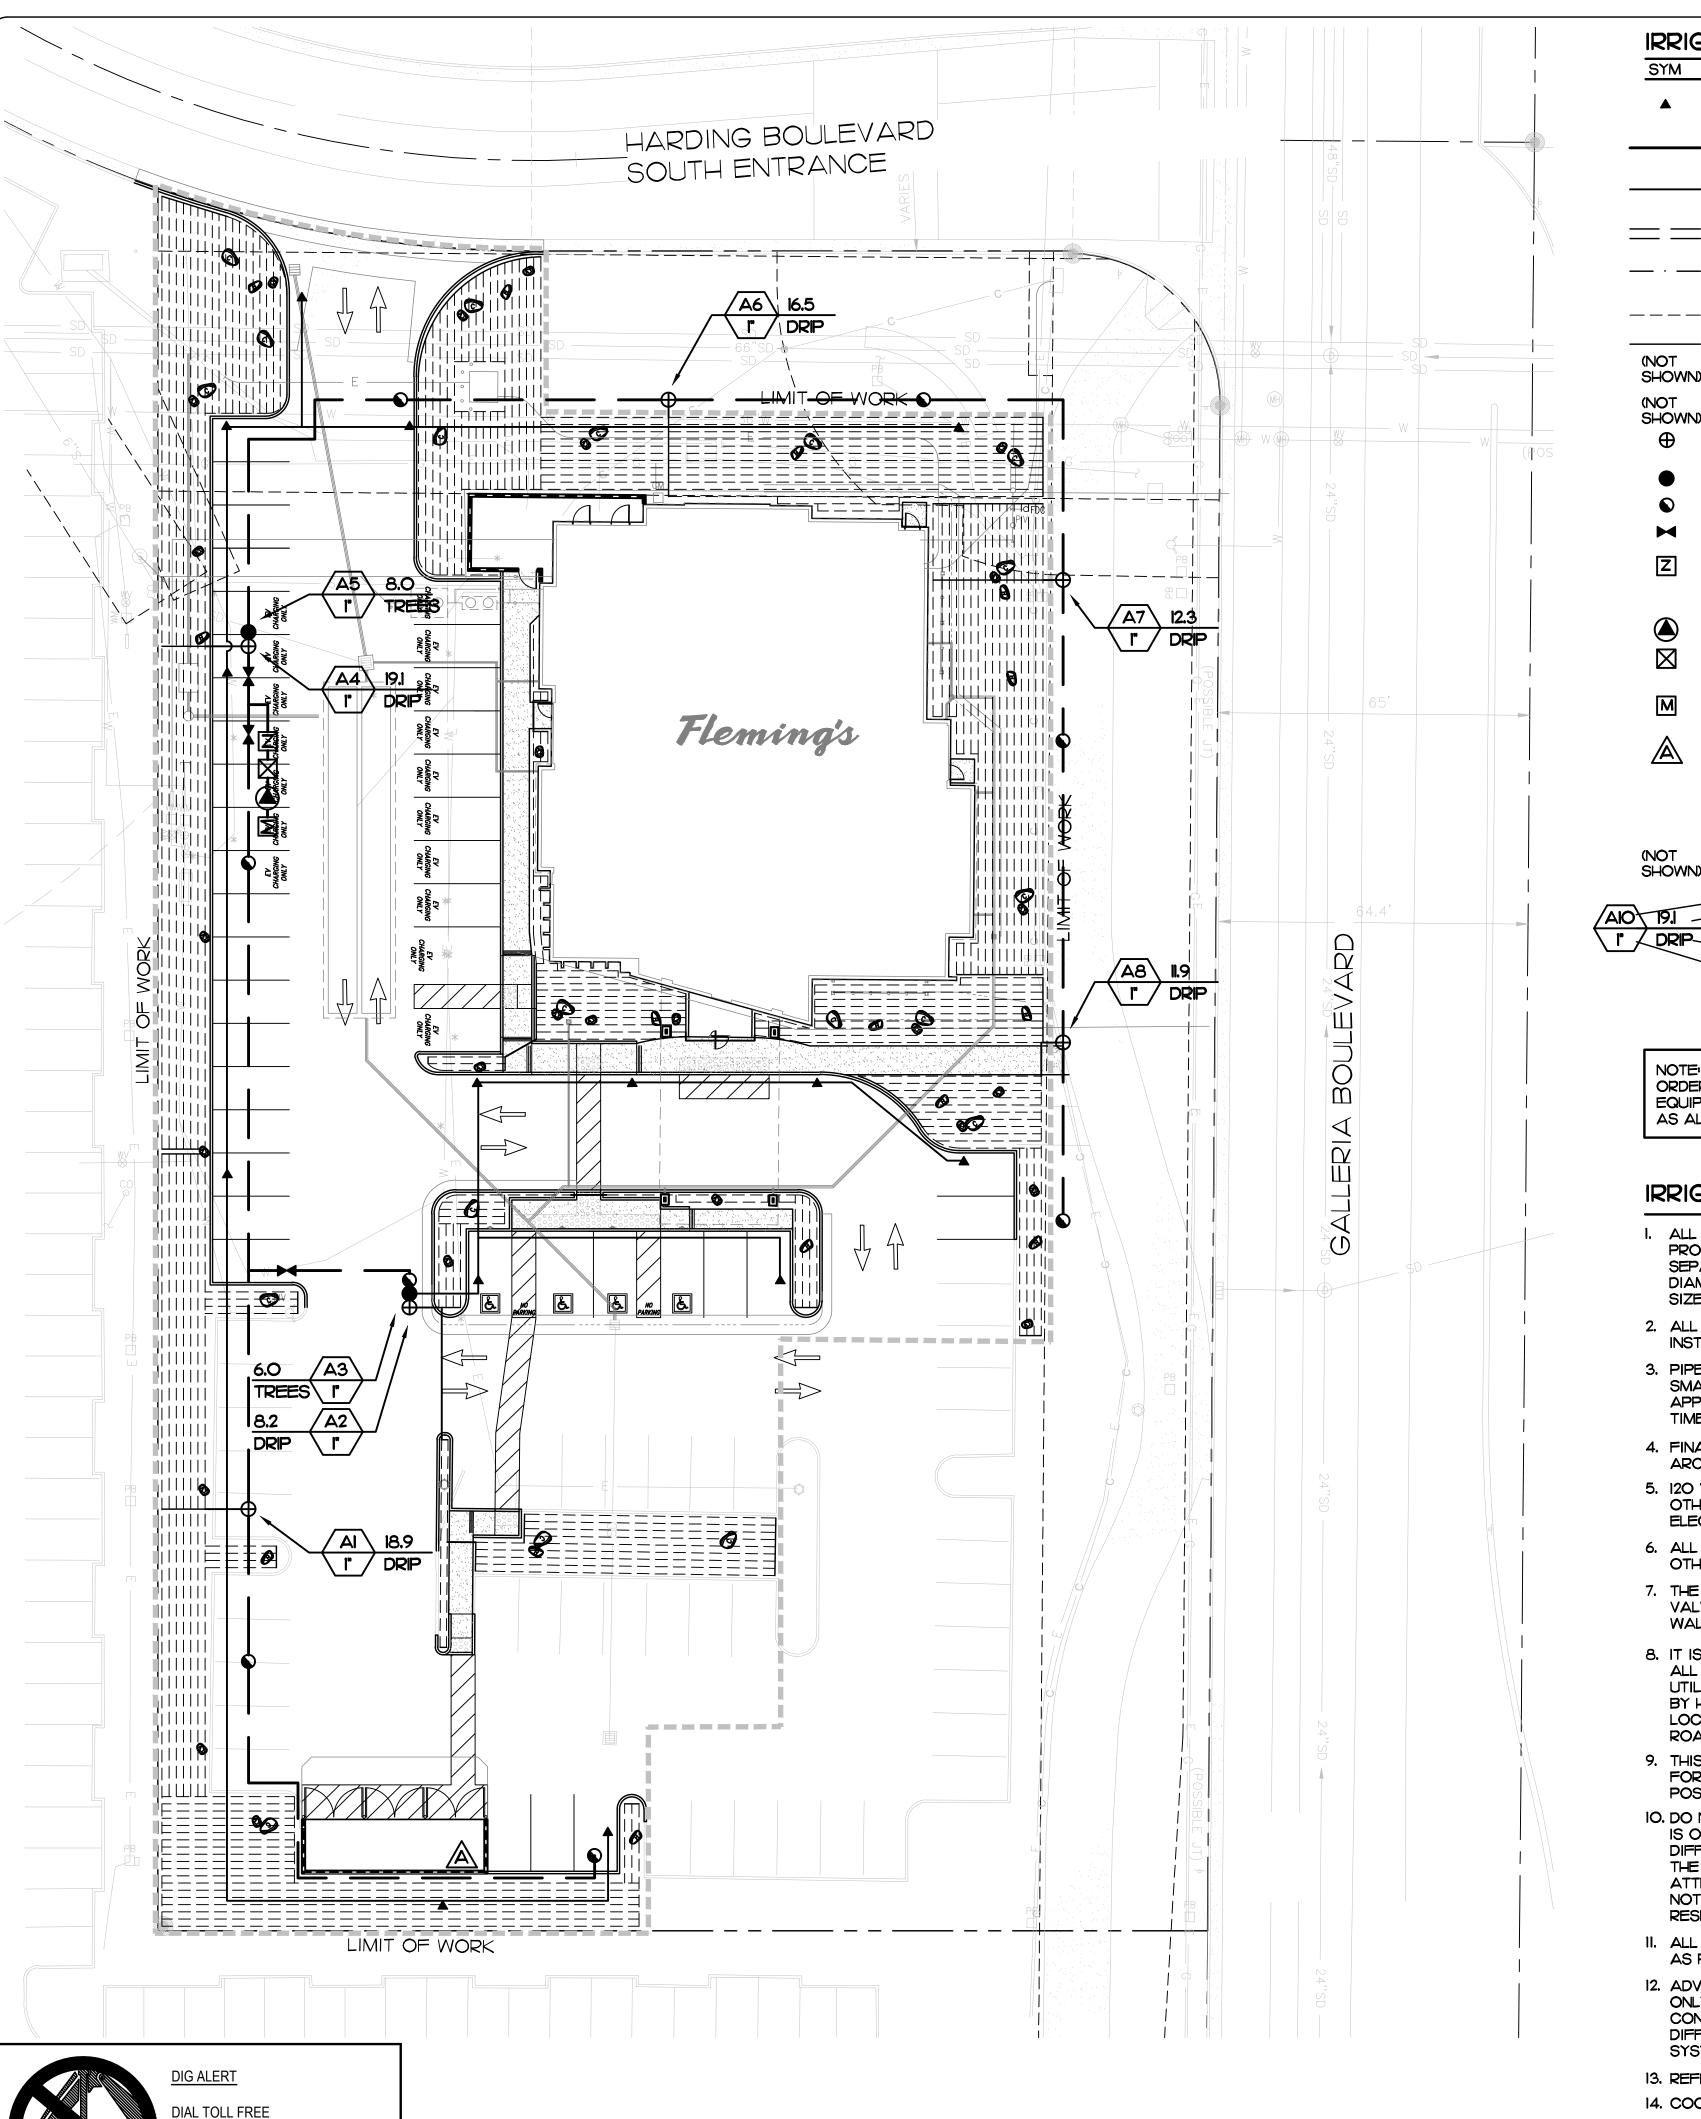

UNDERGROUND SERVICE ALERT

OF SOUTHERN CALIFORNIA

IRRIGATION LEGEND

<u> 51M</u>	MEG/MODEL NO.	DESCRIPTION	P31	GPM	RAD	PAHERI
	RAIN BIRD RWS-B-C-14O2	ROOT WATERING SYSTEM	30	0.50		FLOOD

PRESSURE MAINLINE IN PLANTER AREA, I-1/2" SCH 40 PVC, SOLVENT WELD, BURY 24" MIN.

NON-PRESSURE LATERAL PVC SCH 40 WITH PVC SCH 40 FITTINGS, BURY MIN. 12" BELOW

GRADE. SIZE NOTED. — PIPE SLEEVING PVC SCH 40. BURY MIN. 24" BELOW GRADE, EXTEND MIN. 12" BEYOND

EDGE OF PAVING.

- WIRE SLEEVING PVC SCH 40. BURY MIN. 24" BELOW GRADE, EXTEND MIN. 12" BEYOND EDGE OF PAVING.

--- RAIN BIRD XFS-06-12 SERIES DRIPLINE TUBING (6 GPH EMITTERS SPACED AT 12" O.C.) RAIN BIRD OF SERIES HEADER (3/4" OR 1" SIZE) - BARBS AT 18" O.C.

RAIN BIRD ARVOSO AIR RELIEF VALVE. REFER TO DETAIL SHOWN)

RAIN BIRD EASY FIT FLUSH CAP. REFER TO DETAIL.

RAIN BIRD XCZ-100-PRF CONTROL ZONE KIT (DRIP VALVE ASSEMBLY) WITH I' DVF VALVE AND 3/4" PR FILTER.

RAIN BIRD 100-PEB REMOTE CONTROL VALVE.

RAIN BIRD 33DLRC QUICK COUPLING VALVE WITH KEY AND RUBBER LOCKING CAP - 3/4".

NIBCO T-580-A LINE SIZED BALL VALVE.

EZ-FLO EZOIO-HC IO GALLON CAPACITY FERTIGATION SYSTEM. REFER TO DETAIL. INSTALL PER MANUFACTURER'S SPECIFICATIONS, NOTE: THIS IS A BID ALTERNATE, CONTRACTOR SHALL PROVIDE SEPARATE LINE ITEM COST TO OWNER.

FEBCO 825Y REDUCED PRESSURE BACKFLOW PREVENTION DEVICE - I"

GRISWOLD #2230 PRESSURE REGULATING MASTER VALVE. (NORMALLY CLOSED). I' SIZE. SET AT 70 PSI.

NEW I' IRRIGATION WATER METER. INSTALLED BY OTHERS. REFER TO CIVIL ENGINEERING PLANS FOR ADDITIONAL INFORMATION.

RAIN BIRD ESP-SMTE SMART MODULAR CONTROL SYSTEM (4 STATION WITH (2) 3-STATION EXPANSION MODULES - FOR A TOTAL OF (IO STATIONS), MOUNT IN VANDAL RESISTANT ENCLOSURE ON OUTSIDE WALL OF TRASH ENCLOSURE. SYSTEM INCLUDES WEATHER SENSOR, INSTALL PER MANUFACTURER'S RECOMMENDATIONS. FINAL LOCATION TO BE APPROVED BY LANDSCAPE ARCHITECT. (WEATHER-BASED).

RAIN BIRD VB SERIES VALVE BOXES OR APPROVED EQUAL

VALVE SEQUENCE NUMBER AIO 19.1 — FLOW IN GPM I" / DRIP HYDROZONE VALVE SIZE

> * NOTE: CONTRACTOR SHALL COMPUTE EXACT FLOW BASED UPON FINAL PLANTING. CONTRACTOR SHALL NOT EXCEED SPECIFIED VALVE CAPACITY IN TERMS OF MANUFACTURER'S RECOMMENDED FLOW VS. FRICTION LOSS SPECIFICATIONS.

NOTE: IRRIGATION PLAN IS DIAGRAMMATIC. CONTRACTOR SHALL ROUTE PIPING IN ORDER TO AVOID OBJECTS LIKE LIGHT STANDARDS, TRANSFORMER PADS, EQUIPMENT VAULTS, SUB-SURFACE ROCK TOO LARGE TO REMOVE, ETC. AS LONG AS ALL PLANTS RECEIVE THE THE PROPER NUMBER OF EMITTERS PER SCHEDULE.

IRRIGATION NOTES

- ALL MAIN LINE PIPING, NON-PRESSURE PIPING AND CONTROL WIRE SLEEVING CROSSING PROTECTED WETLAND AREA AND LOW FLOW SIDE CHANNELS SHALL BE INSTALLED IN SEPARATE SLEEVES. MAIN LINE SLEEVE SIZE SHALL BE A MINIMUM OF TWICE (2X) THE DIAMETER OF THE PIPE TO BE SLEEVED. CONTROL WIRE SLEEVES SHALL BE OF SUFFICIENT SIZE FOR THE REQUIRED NUMBER OF WIRES.
- 2. ALL LATERAL LINE PIPING UNDER PAVING SHALL BE PVC SCHEDULE 40 PIPE AND SHALL BE INSTALLED PRIOR TO PAVING.
- 3. PIPE SIZES SHALL CONFORM TO THOSE SHOWN ON THE DRAWINGS. NO SUBSTITUTIONS OF SMALLER PIPE SIZES SHALL BE PERMITTED, BUT SUBSTITUTIONS OF LARGER SIZES MAY BE APPROVED. ALL DAMAGED AND REJECTED PIPE SHALL BE REMOVED FROM THE SITE AT THE TIME OF SAID REJECTION.
- 4. FINAL LOCATION OF THE AUTOMATIC CONTROLLER SHALL BE APPROVED BY LANDSCAPE ARCHITECT.
- 5. I2O VAC ELECTRICAL POWER SOURCE AT CONTROLLER LOCATION SHALL BE PROVIDED BY OTHERS. THE IRRIGATION CONTRACTOR SHALL MAKE THE FINAL CONNECTION FROM THE ELECTRICAL SOURCE TO THE CONTROLLER.
- 6. ALL SPRINKLER/BUBBLER HEADS SHALL BE SET PERPENDICULAR TO FINISH GRADE UNLESS OTHERWISE SPECIFIED.
- 7. THE IRRIGATION CONTRACTOR SHALL FLUSH AND ADJUST ALL SPRINKLER HEADS AND VALVES FOR OPTIMUM COVERAGE WITH MINIMAL OVERSPRAY ONTO WALKS, STREETS WALLS, ETC.
- 8. IT IS THE RESPONSIBILITY OF THE IRRIGATION CONTRACTOR TO FAMILIARIZE HIMSELF WITH ALL GRADE DIFFERENCES, LOCATION OF WALLS, RETAINING WALLS, STRUCTURES AND UTILITIES. THE IRRIGATION CONTRACTOR SHALL REPAIR OR REPLACE ALL ITEMS DAMAGED BY HIS WORK, HE SHALL COORDINATE HIS WORK WITH OTHER CONTRACTORS FOR THE LOCATION AND INSTALLATION OF PIPE SLEEVES AND LATERALS THROUGH WALLS, UNDER ROADWAYS AND PAVING, ETC.
- 9. THIS DESIGN IS DIAGRAMMATIC. ALL PIPING, VALVES, ETC. SHOWN WITHIN PAVED AREAS ARE FOR DESIGN CLARIFICATION ONLY AND SHALL BE INSTALLED IN PLANTING AREAS WHEREVER POSSIBLE. THE CONTRACTOR SHALL LOCATE ALL VALVES IN SHRUB AREAS.
- 10. DO NOT WILLFULLY INSTALL THE SPRINKLER SYSTEM AS SHOWN ON THE DRAWINGS WHEN IT IS OBVIOUS IN THE FIELD THAT UNKNOWN OBSTRUCTIONS, GRADE DIFFERENCES OR DIFFERENCES IN THE AREA DIMENSIONS EXIST THAT MIGHT NOT HAVE BEEN CONSIDERED IN THE ENGINEERING. SUCH OBSTRUCTIONS OR DIFFERENCES SHOULD BE BROUGHT TO THE ATTENTION OF THE OWNER'S AUTHORIZED REPRESENTATIVE. IN THE EVENT THIS NOTIFICATION IS NOT PERFORMED, THE IRRIGATION CONTRACTOR SHALL ASSUME FULL RESPONSIBILITY FOR ANY REVISIONS NECESSARY.
- II. ALL SPRINKLER EQUIPMENT NOT OTHERWISE DETAILED OR SPECIFIED SHALL BE INSTALLED AS PER MANUFACTURER'S RECOMMENDATIONS AND SPECIFICATIONS.
- 12. ADV (ANTI-DRAIN VALVES) UNITS AS SHOWN IN THE DETAILS ARE FOR TYPICAL INSTALLATION ONLY, AND MAY NOT BE REQUIRED ON ALL HEADS. PRIOR TO INSTALLATION THE CONTRACTOR SHALL VERIFY WITH THE ON-SITE GRADES. IF THERE IS AN ELEVATION DIFFERENCE OF 24" OR MORE BETWEEN THE HIGHEST HEAD AND LOWEST HEAD ON A SYSTEM, THE ADV'S SHALL BE INSTALLED PER THE DETAIL.
- 13. REFER TO SPECIFICATIONS FOR STANDARDS OF MATERIALS AND WORKMANSHIP.
- 14. COORDINATE LATERAL PIPE SLEEVING PRIOR TO INSTALLATION OF CONCRETE
- 15. REFER TO CIVIL ENGINEER PLANS FOR GRADING, ANY DRAINAGE STRUCTURES AND METERS. COORDINATE LOCATION OF IRRIGATION EQUIPMENT WITH CIVIL ENGINEER INFORMATION.

POINT OF CONNECTION:

CONNECT TO NEW I" IRRIGATION WATER METER (PER CIVIL ENGINEERING PLANS - PROVIDED BY GENERAL CONTRACTOR). PROVIDE I' BACKFLOW PREVENTION DEVICE, I' MASTER VALVE, FERTIGATION SYSTEM AND BALL VALVES AS SHOWN. LOCATE ALL EQUIPMENT IN SHRUB AREA AND WITHIN LIMIT OF WORK. DRAWING SHOWN FOR CLARITY ONLY. REFER TO LEGEND FOR ADDITIONAL INFORMATION.

> STATIC PRESSURE: DESIGN PRESSURE: 56 PSI MAXIMUM FLOW (GPM): 18.1 GPM

THE LANDSCAPE CONTRACTOR SHALL VERIFY STATIC WATER PRESSURE ON-SITE AND TO NOTIFY THE LANDSCAPE ARCHITECT OF ANY DISCREPANCIES. FAILURE TO DO SO MAY RESULT IN CHANGES TO THE IRRIGATION SYSTEM IN THE FIELD AT NO ADDITIONAL CHARGE TO THE OWNER.

CONTROLLER LOCATION:

120 VOLT 2 AMP 60 CYCLE POWER AVAILABLE. LOCATE CONTROLLER IN WALL MOUNT VANDAL RESISTANT ENCLOSURE. IRRIGATION CONTRACTOR TO MAKE FINAL HOOK-UP OF FIELD WIRES. INSTALL WITH WEATHER STATION PER MANUFACTURER'S RECOMMENDATIONS. REFER TO LEGEND FOR ADDITIONAL INFORMATION.

CONSTRUCTION NOTE:

LANDSCAPE CONTRACTOR SHALL COORDINATE WITH THE GENERAL CONTRACTOR FOR THE INSTALLATION OF PIPE AND WIRE SLEEVES THROUGH WALLS AND BENEATH CONCRETE OR ASPHALT PAVING PRIOR TO POURING PAVING.

PSI LOSS CALCULATIONS:


VALVE #A6 23.0 GPM (WORST CASE)	
WATER METER - H/2" BACKFLOW PREVENTER 2" MAINLINE - PVC CLASS 315 (560 LF) PVC LATERALS FITTINGS REMOTE CONTROL VALVE PRESSURE REQUIRED AT HEAD ELEVATION LOSS MISCELLANEOUS	I.IO II.OO 2.7O 4.OO I.OO 3.7O 30.OO 0.OO 2.OO
TOTAL PRESSURE LOSS STATIC PRESSURE RESIDUAL PRESSURE	55.50 70.00 14.50

PIPE SIZING CHART

PIPE SIZE	FLOW (GPM)
3/4"	0-8
1"	8-12
1-1/4"	12-20
1-1/2"	20-30
2"	30 +

SCALE: 1"=20'



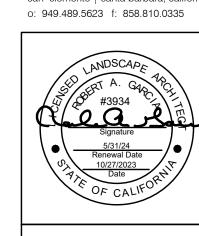

City of Roseville Approval

10/27/2023 DRAWN BY CHECKED BY JOB NO. BLB23026 SHEET NO. ___ OF 4 SHEETS

RIG Δ


WATER CONSERVATION IS ACHIEVED IN THIS LANDSCAPE CONSTRUCTION DOCUMENT AS DESCRIBED BELOW,

- I. ALL PLANT MATERIALS SELECTED FOR THIS SITE ARE APPROPRIATE FOR THE GEOGRAPHICAL LOCATION AND LOCAL CLIMATE, AND THEIR ADAPTABILITY TO DROUGHT, DATA FROM WUCOLS III HAS BEEN USED FOR DETERMINING THE SPECIES' PLANT FACTOR FOR THE WATER USE CALCULATIONS.
- 2. PLANTS WITH SIMILAR WATER USE REQUIREMENTS ARE GROUPED TOGETHER.
- 3. THE MAJORITY OF LANDSCAPE AREAS ARE PLANTED WITH LOW WATER USE PLANTS, WITH THE BALANCE IN MODERATE WATER USE PLANTS. NO HIGH WATER USE PLANTS ARE USED.
- IRRIGATION SECTIONS: HYDROZONES ARE SEPARATED BY CONSIDERING PLANT SPECIES FACTOR, PLANT DENSITY AND MICROCLIMATE, IF LOW WATER USE PLANTS ARE MIXED WITH MODERATE WATER USE PLANTS IN THE SAME HYDROZONE. THE MODERATE WATER USE FACTOR IS USED FOR WATER USE CALCULATIONS. SEE HYDROZONE EXHIBIT.
- THE IRRIGATION SYSTEM UTILIZES A LOW-VOLUME DISTRIBUTION SYSTEM WITH A MASTER VALVE, FLOW SENSOR, CHECK VALVES, ET BASED AUTOMATIC CONTROLLERS WITH CYCLE PLUS SOAK AND WATER BUDGETING CAPABILITY, WEATHER STATION, AND RAIN SHUT-OFF.
- 6. THE USE OF TURF IS ELIMINATED, ALL TREE, SHRUB AND GROUNDCOVER AREAS WILL BE DRESSED WITH A 3" LAYER OF MULCH FOR MOISTURE RETENTION AND TO DISCOURAGE WEEDS.
- THERE ARE NO SPECIAL LANDSCAPE AREAS IN THIS PROJECT.

WATER EFFICIENT LANDSCAPE WORKSHEET This worksheet is filled out by the project applicant and it is a required element of the Landscape Documentation Package.

Appendix B – Sample Water Efficient Landscape Worksheet

Reference Evapotranspiration (ETo) 50.54

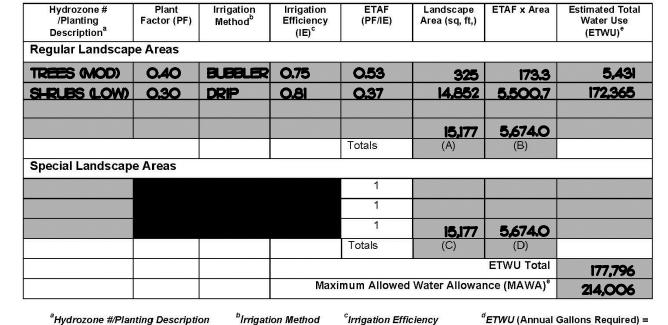

0.75 for spray head overhead spray or drip 2.) low water use plantings 3.) medium water use planting *MAWA (Annual Gallons Allowed) = (Eto) (0.62) [(ETAF x LA)

+ ((1-ETAF) x SLA)] where 0.62 is a conversion factor that converts acreinches per acre per year to gallons per square foot per

is the total special landscape area in square feet, and ETAF is .55 for residential areas and 0.45 for non-

ETAF Calculations

Regular Landscape Areas

All Landscape Areas

Total ETAF x Area (B) **5,674.0** Total Area Average ETAF B ÷ A **0.374**

Average ETAF for Regular Landscape Areas must be 0.55 or below for residential areas, and 0.45 or below for non-residential areas.

Eto x 0.62 x ETAF x Area

factor that converts acre-

inches per acre per year to gallons per square foot pe

Total ETAF x Area (B+D) 5,674.0 Total Area 15,177 Sitewide ETAF (B+D) ÷ (A+C)

Hourian Associates

Dear Nicole,

107 Avenida Miramar, Suite D

San Clemente, CA 92672

Nicole Hourian, team@hourianassociates.com

General soil preparation on a square foot basis. Broadcast the following uniformly; rates are per 1,000 square feet for a 6-inch lift. Incorporate them homogeneously 6" deep.

Nitrogen, phosphorus and sulfur are low. Boron is modest. Potassium is moderate. Iron,

manganese, zinc, copper and magnesium are high. Sodium is low. SAR (sodium

adsorption ratio) is 0.4. The concentrations of common non-essential heavy metals are

WALLACE LABORATORIES, LLC **365 Coral Circle**

El Segundo, CA 90245

phone (310) 615-0116 fax (310) 640-6863

July 14, 2023

RE: Flemings, Roseville

Sample received July 12, 2023, Our ID No. 23-194-57

Ammonium sulfate (21-0-0) - 5 pounds Potassium sulfate (0-0-50) - 6 pounds Triple superphosphate (0-45-0) - 4 pounds Agricultural gypsum - 10 pounds Organic soil amendment - about 4 cubic yards, sufficient for 3% to 5% soil organic matter on a dry weight basis

The pH is moderately alkaline at 7.46. Salinity is low at 0.29 millimho/cm.

For the preparation on a volume basis, homogeneously blend the following materials into the soil. Rates are expressed per cubic yard:

Ammonium sulfate (21-0-0) -1/4 pound Potassium sulfate (0-0-50) - 1/4 pound Triple superphosphate (0-45-0) - 1/4 pound Agricultural gypsum – 1/2 pound Organic soil amendment - about 20% by volume, sufficient for 3% to 5% soil organic matter on a dry weight basis

Organic soil amendment:

- . Humus material shall have an acid-soluble ash content of no less than 6% and no
- more than 20%. Organic matter shall be at least 50% on a dry weight basis. 2. The pH of the material shall be between 6 and 7.5.

Soil Analyses Plant Analyses Water Analyses

Hourian Associates, July 14, 2023, page 2

3. The salt content shall be less than 10 millimho/cm @ 25° C. on a saturated paste

7. Types of acceptable products are composts, manures, mushroom composts, straw,

8. Composted wood products are conditionally acceptable [stable humus must be

11. The compost shall be aerobic without malodorous presence of decomposition

12. The maximum particle size shall be 0.5 inch, 80% or more shall pass a No. 4 screen

Maximum total permissible pollutant concentrations in amendment in parts per

alfalfa, peat mosses etc. low in salts, low in heavy metals, free from weed seeds,

present]. Wood based products are not acceptable which are based on red wood or

4. Boron content of the saturated extract shall be less than 1.0 part per million.

6. Calcium carbonate shall not be present if to be applied on alkaline soils.

5. Silicon content (acid-insoluble ash) shall be less than 50%.

free of pathogens and other deleterious materials.

9. Sludge-based materials are not acceptable.

10. Carbon:nitrogen ratio is less than 25:1

million on a dry weight basis:

for soil amending.

arsenic

about once per quarter.


cadmium

MAINTENANCE MANUAL

THIS MANUAL TO BE KEPT AT THE CONTROLLER LOCATION AT ALL TIMES.

IRRIGATION SYSTEMS:

- AUTOMATIC CONTROLLER TO BE CHECKED MONTHLY BY LANDSCAPE MAINTENANCE FOREMAN AND CHECKED WEEKLY BY MAINTENANCE CREW LEADER. TO PROVIDE OPTIMUM PLANT GROWTH AND WATER CONSERVATION. (IF SMART CONTROLLER IS IN USE, CHECK ELECTRICAL POWER ONLY)
- 2. LANDSCAPE MAINTENANCE CONTRACTOR TO CHECK ALL SYSTEMS ONCE PER MONTH BY TURNING ON EACH SYSTEM MANUALLY.
- 3. LANDSCAPE MAINTENANCE CONTRACTOR TO VISUALLY CHECK ALL SYSTEMS EVERY WEEK DURING MAINTENANCE OF LANDSCAPE.
- 4. ALL IRRIGATION FILTERS AT THE WYE STRAINER (AT THE BACKFLOW DEVICE) AND ALL FILTERS AT THE DRIP IRRIGATION VALVES TO BE CLEANED MONTHLY OR AS NEEDED.
- 5. CHECK RAIN SHUT OFF DEVICE AT THE BEGINNING OF THE RAINY SEASON AND RE-CALIBRATE AS NEEDED. MAKE SURE DEVICE IS CLEAN, FREE OF ANY DEBRIS, AND IN GOOD WORKING ORDER.
- 6. BACKFLOW DEVICE TO BE VISUALLY CHECKED ON A MONTHLY BASIS. TEST AND RE-CERTIFY ANNUALLY AS PER ALL CODES AND ORDINANCES.
- 7. SCHEDULE ALL SPRAY SYSTEMS TO RUN ONLY BETWEEN THE HOURS OF 2:00 AM AND 9:00 AM.
- 8. ON A MONTHLY BASIS, FLUSH ALL DRIP SYSTEM LINES AND CHECK VALVE BOXES TO SEE THAT THEY DRAIN PROPERLY. CLEAN OUT ANY DEBRIS, MUD OR PLANT GROWTH ANNUALLY.
- 9. TWICE A YEAR CHECK ALL QUICK COUPLERS AND MAKE ALL REPAIRS AS NECESSARY, REPLACE PEA GRAVEL IN VALVE BOXES AS NEEDED.
- FREEZING WEATHER.
- YEARS FROM OPENING OF STORE.

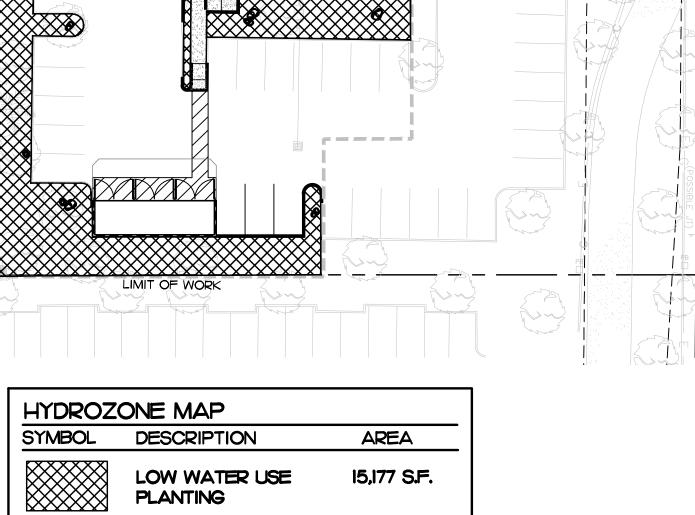

15,177 S.F.

15,177 S.F.

15,177 S.F.

osf.

SCALE: 1"=30'

HARDING BOULEVARD

LIMIT OF WORK

SOUTH ENTRANCE

Flemings

 \triangleleft

 \Longrightarrow

TOTAL

LANDSCAPE CALCULATIONS

HYDROZONE MAP

SHRUB GROUNDCOVER AREA:

TOTAL LANDSCAPE AREA:

TURF AREA:

/ATIOI T ERV, ORT ONS! REP ER O $\geqslant \Box$ >-< **VZ** Z Σ \Box

2 <u>Д</u> DATE 10/27/2023 DRAWN BY CHECKED BY JOB NO. BLB23026

SHEET NO.

— 4

OF 4 SHEETS

City of Roseville Approval

hourian associates, in

landscape architecture + design

san clemente | santa barbara, california

o: 949.489.5623 f: 858.810.0335

#3934 Q Q

50 chromium 200 vanadium 200 Higher amounts of salinity or boron may be present if the soils are to be preleached to reduce the excess or if the plant species will tolerate the salinity

200

silver

and/or boron. For site maintenance, apply ammonium sulfate (21-0-0) at 5 pounds per 1,000 square feet

Monitor the site with periodic soil and leaf tissue testing. Adjust the maintenance program as needed.

Sincerely, Darn a Wallace Garn A. Wallace, Ph. D. GAW:n

Soil Analyses Plant Analyses Water Analyses

WALLACE LABS SOILS REPORT Jul. 13, 2023 Print Date 365 Coral Circle Flemings, Roseville El Segundo, CA 90245 Nicole Hourian, Hourian (310) 615-0116 ammonium bicarbonate/DTPA * * * * high, * * * * very high extractable - mg/kg soil Sample Description | Soil Sample Received 07/12/2023 Interpretation of data low medium high elements 0 - 7 8-15 over 15 1.52 * 0-60 60 -120 121-180 70.49 *** potassium 12.08 **** 0 - 4 4 - 10 over 10 2.69 **** 0- 0.5 0.6- 1 over 1 2.27 **** 0 - 1 1 - 1.5 over 1.5 0- 0.2 0.3- 0.5 over 0.5 1.74 **** copper 0- 0.2 0.2- 0.5 over 1 0.16 ** boron 483.79 **** 146.90 **** magnesium 34.35 * sodium sulfur 6.92 * molybdenum nd * 0.24 * nickel The following trace nd * elements may be toxic 2.96 * The degree of toxicity 0.03 * depends upon the pH of cadmium nd * the soil, soil texture, chromium organic matter, and the cobalt nd * concentrations of the individual elements as well nd * nd * as to their interactions. mercurv nd * The pH optimum depends nd * 1.82 * upon soil organic matter and clay contentnd * for clay and loam soils: 0.28 * under 5.2 is too acidic 6.5 to 7 is ideal Saturation Extract over 8.0 is too alkaline pH value The ECe is a measure of 0.29 * the soil salinity: mho/cm) 1-2 affects a few plants 2-4 affects some plants, > 4 affects many plants. 10.0 cation sun problems over 150 ppm good 20 - 30 ppm nitrate as N phosphorus as P n.d. sulfate as S anion sun 0.08 * toxic over 1 for many plants boron as B increasing problems start at 3 SAR 0.4 est. gypsum requirement-lbs./1000 sq. ft. slow estimated soil texture sandy loam lime (calcium carbonate) organic matter low/fair 20.4% moisture content of soil

half saturation percentag

Elements are expressed as mg/kg dry soil or mg/l for saturation extract.

Analytical data determined on soil fraction passing a 2 mm sieve.


pH and ECe are measured in a saturation paste extract, nd means not detected

7/12/23 Receive Date

19 9%

10. COVER OR PROTECT ALL BACKFLOW DEVICES DURING

OWNER TO PROVIDE FOR A WATER AUDIT EVERY FIVE

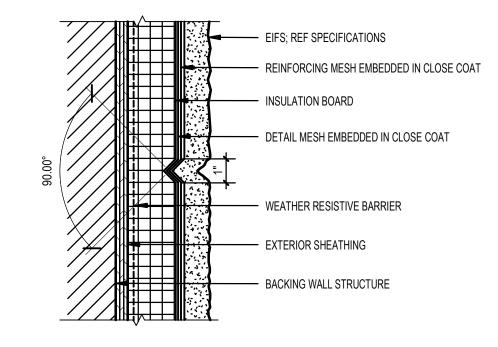

TYPICAL EIFS REVEAL A300 3" = 1'-0"

GENERAL NOTES

- A. SIGNAGE, UNDER SEPARATE PERMIT, SHOWN FOR GENERAL LOCATION ONLY, REF APPROVED SIGN DRAWINGS BY SIGNAGE COMPANY.
- B. CONTRACTOR TO SUPPLY REQUIRED POWER AND CONNECTION TO SIGN, COORDINATE WITH SIGN CONTRACTOR.
- C. REF FINISH SCHEDULE FOR EXTERIOR FINISHES AND COLORS. D. REF STOREFRONT DETAILS SHEET FOR ALUMINUM STOREFRONT INFORMATION AND GLAZING NOTES.
- E. REF EXTERIOR WALL TYPES SHEET FOR EXTERIOR WALLS CRITERIA AND EXTERIOR WALL TYPES. F. EXTERIOR CAULK AND JOINT SEALANT COLOR TO MATCH ADJACENT EXTERIOR WALL FINISH. SEND COLOR SAMPLE TO BBI CPM FOR REVIEW AND APPROVAL.

SHEET KEYNOTES

- 1 PRE-FABRICATED TRELLIS SYSTEM, SUPPLIED BY VENDOR, INSTALLED BY GC. REFER TO STRUCTURAL AND ARCHITECTURAL SECTIONS FOR REQUIRED BLOCKING AND ATTACHMENT DETAILS. MANUFACTURER: FENWALL; CONTACT: MICHAEL CALDERONE;
- 2 ALUMINUM CURTAIN WALL SYSTEM AND DOORS. REF A800 AND A801 SHEETS FOR SCHEDULES AND DETAILS.
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- 6 RECESSED LINEAR LIGHT FIXTURE, INSTALLED VERTICALLY IN ACM PANELS, SEE ELECTRICAL DRAWINGS AND DETAIL FOR ADDITIONAL INFORMATION
- 7 PRE-FABRICATED MECHANICAL EQUIPMENT SCREEN, SUPPLIED BY VENDOR, INSTALLED BY GC. REFER TO STRUCTURAL AND ARCHITECTURAL SECTIONS FOR REQUIRED BLOCKING AND ATTACHMENT DETAILS. MANUFACTURER: FENWALL; CONTACT: MICHAEL CALDERONE; (813) 343-597
- 8 EXTERIOR WALL SCONCE, REF ELECTRICAL 9 SERVICE/ TRASH ENCLOSURE; REF A410
- 10 SINGLE PLY ROOF MEMBRANE ON VERTICAL SURFACE OF WALL AS INDICATED, REF. B5/A601.

EXTERIOR BUILDING LIGHT INSERTS IN ACM PANELS, SEE ELECTRICAL DRAWINGS AND DETAILS.

- 11 DIRECTION OF ACM PANEL FINISH AS INDICATED BY ARROW, TYP. EXTERIOR BUILDING LIGHT INSERTS IN ACM PANELS, SEE ELECTRICAL DRAWINGS AND DETAILS.
- 12 1/2" VERTICAL ACM REVEAL BY ACM PANEL MFR. FINISH TO MATCH ADJACENT PANEL FACE.
- 13 3" HORIZONTAL ACM REVEAL BY ACM PANEL MFR. FINISH TO BE BLACK. 14 ROOF AND OVERFLOW DRAIN PIPES IN THE WALL, TIE INTO STORM SYSTEM. REF: CIVIL

EXTERIOR FINISH SCHEDULE

TYPE	MFR	DESCRIPTION	COLOR	NOTES
ACM PANEL				
ACM-01	ALPOLIC	ACM PANELS, ALPOLIC / PE	MBX METALLIC BRONZE	SUPPLIED BY CENTURION/TFC CANOP' REFER TO INTERIOR ELEVATIONS FOR INSTALL/GRAIN DIRECTION
ACM-02	ALPOLIC	ACM PANELS, ALPOLIC / PE	JBR BRONZE	SUPPLIED BY CENTURION/TFC CANOPY REFER TO INTERIOR ELEVATIONS FOR INSTALL/GRAIN DIRECTION
CONCRETE M	ASONRY UNITS			
CMU-1	REGALSTONE CONCRETE BLOCKS	8" X 8" X 16" SMOOTH FINISH	CHARCOAL	OR APPROVED EQUAL
CMU-2	REGALSTONE CONCRETE BLOCKS	8" X 8" X 16" SPLIT FACE FINISH	CHARCOAL	OR APPROVED EQUAL
EIFS				
EF-01	DRYVIT	OUTSULATION PLUS MD, TERRANEO	WHITE	
EF-02	DRYVIT	OUTSULATION PLUS MD	#452ST STORMY NITE	SANDPEBBLE FINE FINISH
EXTERIOR PA	INT			
PT-01	SHERWIN WILLIAMS	URBANE BRONZE	SW7048	
METAL				
MT-01	EXCEPTIONAL METALS	PRE-FINISHED METAL COPING	DARK BRONZE	
MT-03	EXCEPTIONAL METALS	PRE-FINISHED METAL COPING/GRAVEL STOP	BONE WHITE	
MT-04	BERRIDGE	BRAKE METAL, 24 GA.	DARK BRONZE TO MATCH STOREFRONT FRAMING	
MT-05	BERRIDGE	FLUSH SEAM SOFFIT PANELS	HONEY WALNUT	
MT-06	EXCEPTIONAL METALS	PRE-FINISHED METAL COPING/GRAVEL STOP	MEDIUM BRONZE	
MT-07	MAPES PANELS	MAPES SHAPES INFILL PANEL	DARK BRONZE TO MATCH STOREFRONT FRAMING	
MT-19	BY G.C.	1-1/2" GALVANIZED METAL DECKING, 22 GA.	PT-01	
STOREFRONT				
SF-01	KAWNEER	ALUMINUM STOREFRONT	DARK BRONZE	
J. V.				





520 South Main Street, Suite 2531 Akron, OH 44311 330.572.2100 Fax 330.572.2101 PRELIMINARY DRAFT NOT FOR CONSTRUCTION, BID, RELIANCE, RECORDING PURPOSES OR IMPLEMENTATION.

SHEET ISSUE:


PRINCIPAL IN CHARGE: PROJECT ARCHITECT: DRAWN BY:

SHEET TITLE: **EXTERIOR ELEVATIONS**

PROJ. NO. 2023231.52

DS/TB

A300

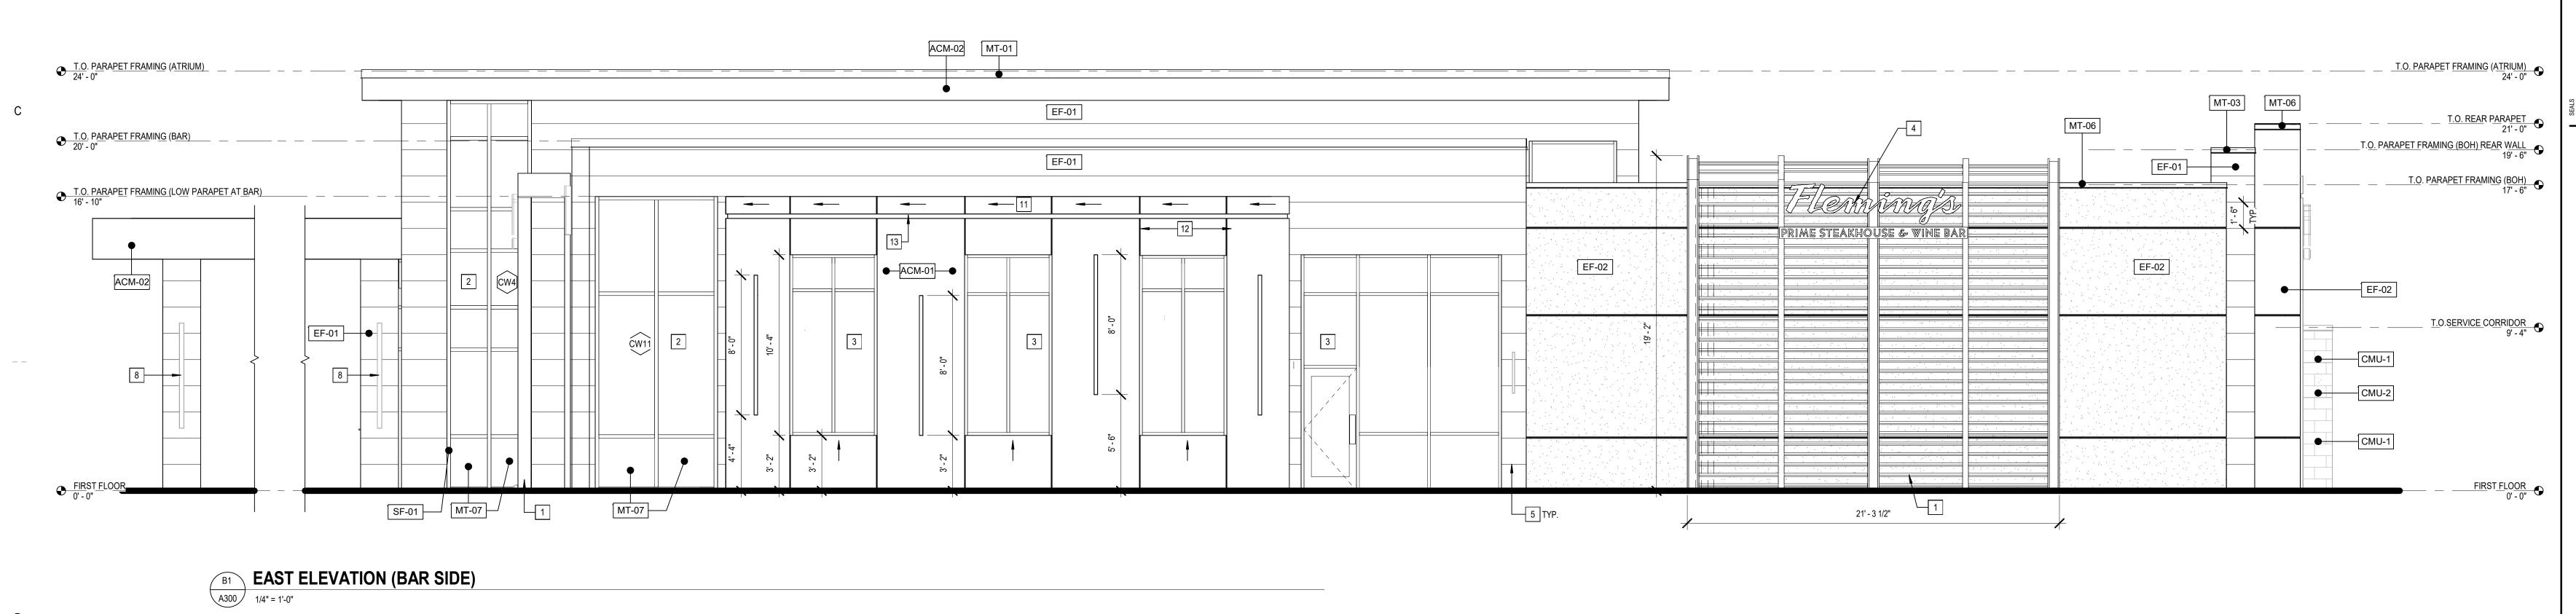



A1 SOUTH ELEVATION (FRONT)
A300 1/4" = 1'-0"

MT-19

TYP. EF-01

GENERAL NOTES

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METAL				
MT-01	EXCEPTIONAL METALS	PRE-FINISHED METAL COPING	DARK BRONZE	
MT-03	EXCEPTIONAL METALS	PRE-FINISHED METAL COPING/GRAVEL STOP	BONE WHITE	
	EXCEPTIONAL		DARK BRONZE TO MATCH STOREFRONT FRAMING	
MT-04	EXCEPTIONAL METALS	STOP	DARK BRONZE TO MATCH	
MT-03 MT-04 MT-05 MT-06	EXCEPTIONAL METALS BERRIDGE	STOP BRAKE METAL, 24 GA.	DARK BRONZE TO MATCH STOREFRONT FRAMING	
MT-04 MT-05	EXCEPTIONAL METALS BERRIDGE BERRIDGE EXCEPTIONAL	STOP BRAKE METAL, 24 GA. FLUSH SEAM SOFFIT PANELS PRE-FINISHED METAL COPING/GRAVEL	DARK BRONZE TO MATCH STOREFRONT FRAMING HONEY WALNUT	
MT-04 MT-05 MT-06	EXCEPTIONAL METALS BERRIDGE BERRIDGE EXCEPTIONAL METALS	STOP BRAKE METAL, 24 GA. FLUSH SEAM SOFFIT PANELS PRE-FINISHED METAL COPING/GRAVEL STOP	DARK BRONZE TO MATCH STOREFRONT FRAMING HONEY WALNUT MEDIUM BRONZE DARK BRONZE TO MATCH STOREFRONT FRAMING	
MT-04 MT-05 MT-06 MT-07	EXCEPTIONAL METALS BERRIDGE BERRIDGE EXCEPTIONAL METALS MAPES PANELS BY G.C.	STOP BRAKE METAL, 24 GA. FLUSH SEAM SOFFIT PANELS PRE-FINISHED METAL COPING/GRAVEL STOP MAPES SHAPES INFILL PANEL	DARK BRONZE TO MATCH STOREFRONT FRAMING HONEY WALNUT MEDIUM BRONZE DARK BRONZE TO MATCH STOREFRONT FRAMING	





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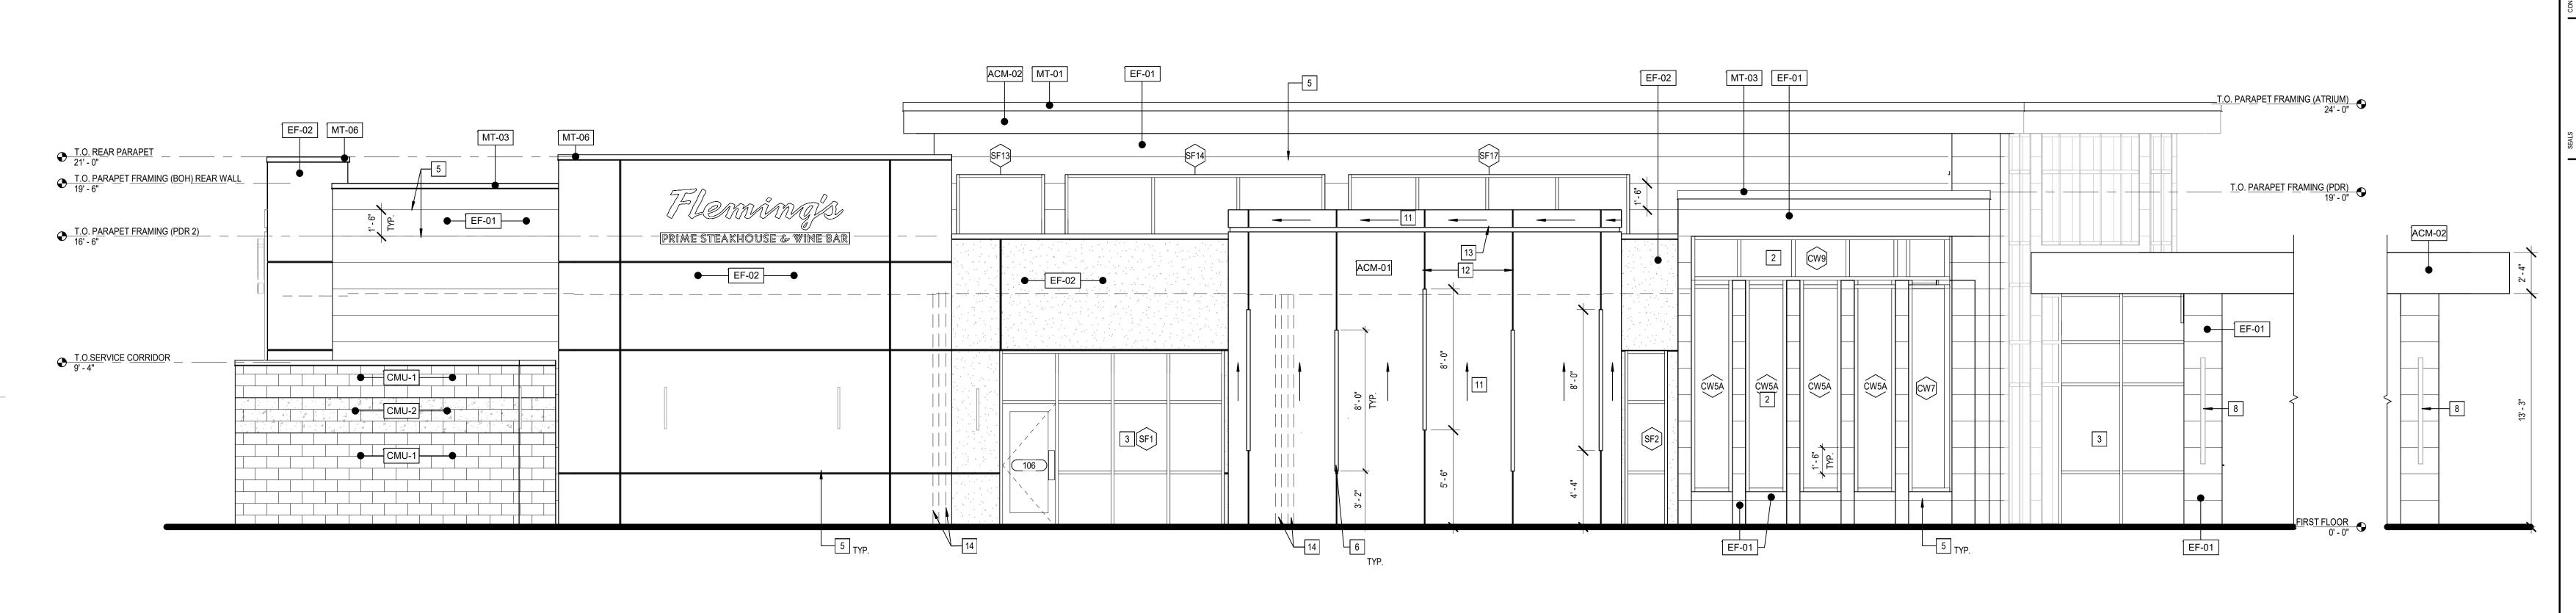
SHEET ISSUE:

PRINCIPAL IN CHARGE: PROJECT ARCHITECT: DRAWN BY:


EXTERIOR ELEVATIONS

PROJ. NO. 2023231.52

A301





B1 WEST ELEVATION (PDR SIDE)
A301 1/4" = 1'-0"

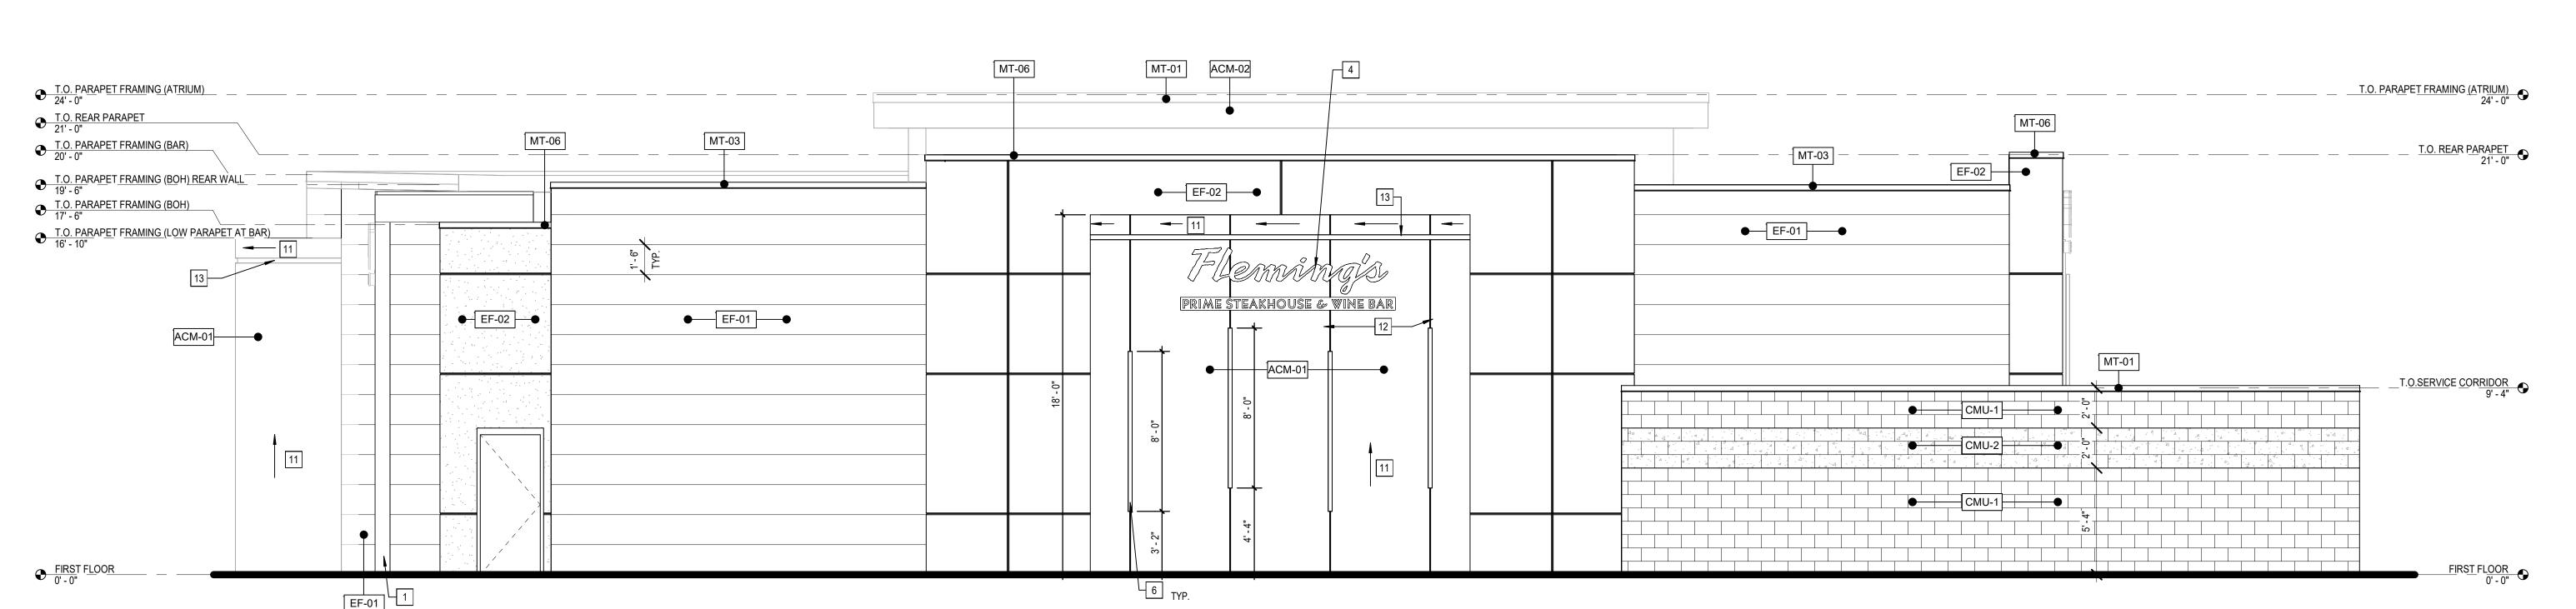

NORTH ELEVATION (REAR SIDE)

A301 1/4" = 1'-0"

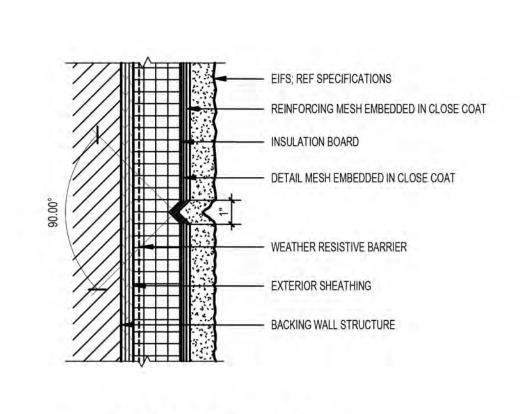

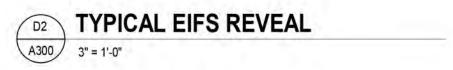

EF-01

EF-01

ACM-01

T.O. PARAPET FRAMING (ATRIUM)

T.O. PARAPET FRAMING (LOW PARAPET AT BAR)
16' - 10"

EF-01

8

B1 EAST ELEVATION (BAR SIDE)
1/4" = 1'-0"

A1 SOUTH ELEVATION (FRONT)

1/4" = 1'-0"

SF-01 MT-07

MT-07

ACM-02

GENERAL NOTES

- A. SIGNAGE, UNDER SEPARATE PERMIT, SHOWN FOR GENERAL LOCATION ONLY, REF APPROVED SIGN DRAWINGS
- BY SIGNAGE COMPANY.
- B. CONTRACTOR TO SUPPLY REQUIRED POWER AND CONNECTION TO SIGN, COORDINATE WITH SIGN
- CONTRACTOR. C. REF FINISH SCHEDULE FOR EXTERIOR FINISHES AND COLORS.
- D. REF STOREFRONT DETAILS SHEET FOR ALUMINUM STOREFRONT INFORMATION AND GLAZING NOTES.
 E. REF EXTERIOR WALL TYPES SHEET FOR EXTERIOR WALLS CRITERIA AND EXTERIOR WALL TYPES. F. EXTERIOR CAULK AND JOINT SEALANT COLOR TO MATCH ADJACENT EXTERIOR WALL FINISH. SEND COLOR SAMPLE TO BBI CPM FOR REVIEW AND APPROVAL.

☐ SHEET KEYNOTES

- 1 PRE-FABRICATED TRELLIS SYSTEM, SUPPLIED BY VENDOR, INSTALLED BY GC. REFER TO STRUCTURAL AND ARCHITECTURAL SECTIONS FOR REQUIRED BLOCKING AND ATTACHMENT DETAILS. MANUFACTURER: FENWALL; CONTACT: MICHAEL CALDERONE;
- 2 ALUMINUM CURTAIN WALL SYSTEM AND DOORS. REF A800 AND A801 SHEETS FOR SCHEDULES AND DETAILS. 3 ALUMINUM STOREFRONT AND DOORS. REF A800 AND A801 SHEETS FOR SCHEDULES AND DETAILS.
- 4 SIGNAGE; SUPPLIED AND INSTALLED BY OTHERS; GC SHALL PROVIDE POWER AND BLOCKING FOR SIGNAGE ATTACHMENT AS REQUIRED. REF. ELECTRICAL DRAWINGS AND APPROVED SIGN PACKAGE.
- 5 EIFS AESTHETIC REVEAL. TYPICAL SPACING AS INDICATED. 6 RECESSED LINEAR LIGHT FIXTURE, INSTALLED VERTICALLY IN ACM PANELS, SEE ELECTRICAL DRAWINGS AND DETAIL FOR
- ADDITIONAL INFORMATION
- EXTERIOR BUILDING LIGHT INSERTS IN ACM PANELS, SEE ELECTRICAL DRAWINGS AND DETAILS. 7 PRE-FABRICATED MECHANICAL EQUIPMENT SCREEN, SUPPLIED BY VENDOR, INSTALLED BY GC. REFER TO STRUCTURAL AND ARCHITECTURAL SECTIONS FOR REQUIRED BLOCKING AND ATTACHMENT DETAILS. MANUFACTURER: FENWALL; CONTACT:
- MICHAEL CALDERONE; (813) 343-597 8 EXTERIOR WALL SCONCE, REF ELECTRICAL

EF-02

5 TYP.

- 9 SERVICE/ TRASH ENCLOSURE; REF A410 10 SINGLE PLY ROOF MEMBRANE ON VERTICAL SURFACE OF WALL AS INDICATED, REF. B5/A601.
- 11 DIRECTION OF ACM PANEL FINISH AS INDICATED BY ARROW, TYP. EXTERIOR BUILDING LIGHT INSERTS IN ACM PANELS, SEE ELECTRICAL DRAWINGS AND DETAILS.

1/2" VERTICAL ACM REVEAL BY ACM PANEL MFR. FINISH TO MATCH ADJACENT PANEL FACE.	
3" HORIZONTAL ACM REVEAL BY ACM PANEL MFR. FINISH TO BE BLACK.	
DOOR AND OVERELOW BRAND DIRECTLY THE WALL THE INTO OTORN OVEREN REF. ON W	

3" HORIZONTAL ACM REVEAL BY ACM PANEL MFR. FINISH TO BE BLACK.
ROOF AND OVERFLOW DRAIN PIPES IN THE WALL. TIE INTO STORM SYSTEM, REF: CIVIL

1/2 VENTICAL ACM REVEAL BY ACM PANEL MICK. FINISH TO MATCH ADJACENT PANEL FACE.
3" HORIZONTAL ACM REVEAL BY ACM PANEL MFR. FINISH TO BE BLACK.
ROOF AND OVERFLOW DRAIN PIPES IN THE WALL. TIE INTO STORM SYSTEM, REF: CIVIL

CM REVEAL BY ACM PANEL MFR. FINISH TO BE BLACK.	MT-05	BERRIDGE	F
LOW DRAIN PIPES IN THE WALL, TIE INTO STORM SYSTEM. REF; CIVIL	MT-06	EXCEPTIONAL	P
		METALS	S

Fleming's

21' - 3 1/2"

OW DDAN DIDEC IN THE WALL. THE INTO STORM SYSTEM DEE: CIVIL	MT-05	BERRIDGE	FLUSH SEAM SOFFIT PANELS
OW DRAIN PIPES IN THE WALL, TIE INTO STORM SYSTEM. REF: CIVIL	MT-06	EXCEPTIONAL METALS	PRE-FINISHED METAL COPING/ STOP
	MT-07	MAPES PANELS	MAPES SHAPES INFILL PANEL

MT-06

EF-01

EF-02

			INSTALL/GRAIN DIRECTION	
SONRY UNITS				11.
REGALSTONE CONCRETE BLOCKS	8" X 8" X 16" SMOOTH FINISH	CHARCOAL	OR APPROVED EQUAL	IN.
REGALSTONE CONCRETE BLOCKS	8" X 8" X 16" SPLIT FACE FINISH	CHARCOAL	OR APPROVED EQUAL	
				1
DRYVIT	OUTSULATION PLUS MD, TERRANEO	WHITE		
DRYVIT	OUTSULATION PLUS MD	#452ST STORMY NITE	SANDPEBBLE FINE FINISH	
T				
SHERWIN WILLIAMS	URBANE BRONZE	SW7048		
EXCEPTIONAL	PRE-FINISHED METAL COPING	DARK BRONZE		N
METALS		5000150050		
EXCEPTIONAL METALS	PRE-FINISHED METAL COPING/GRAVEL STOP	BONE WHITE		
BERRIDGE	BRAKE METAL, 24 GA.	DARK BRONZE TO MATCH STOREFRONT FRAMING		
BERRIDGE	FLUSH SEAM SOFFIT PANELS	HONEY WALNUT		
EXCEPTIONAL METALS	PRE-FINISHED METAL COPING/GRAVEL STOP	MEDIUM BRONZE		4
MAPES PANELS	MAPES SHAPES INFILL PANEL	DARK BRONZE TO MATCH STOREFRONT FRAMING		
BY G.C.	1-1/2" GALVANIZED METAL DECKING, 22 GA.	PT-01		
			- 1	
KAWNEER	ALUMINUM STOREFRONT	DARK BRONZE		g GPD GROU

T.O. PARAPET FRAMING (ATRIUM)
24' - 0"

T.O. PARAPET FRAMING (BOH)

T.O.SERVICE CORRIDOR 9' - 4"

T.O. PARAPET FRAMING (BOH) REAR WALL 19' - 6"

EF-02

COLOR

MBX METALLIC BRONZE SUPPLIED BY

NOTES

CENTURION/TFC CANOPY;

INSTALL/GRAIN DIRECTION

REFER TO INTERIOR

REFER TO INTERIOR ELEVATIONS FOR

ELEVATIONS FOR

SUPPLIED BY CENTURION/TFC CANOPY:

EXTERIOR FINISH SCHEDULE

ACM PANELS, ALPOLIC / PE

ACM PANELS, ALPOLIC / PE

DESCRIPTION

MFR

ALPOLIC

ALPOLIC





SHEET ISSUE:

PRINCIPAL IN CHARGE: PROJECT ARCHITECT: DRAWN BY: SHEET TITLE: **EXTERIOR ELEVATIONS**

PROJ. NO. 2023231.52 SHEET NO.

RO MS DS/ TB

A300




MT-01


SHEET KEYNOTES

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- ADDITIONAL INFORMATION EXTERIOR BUILDING LIGHT INSERTS IN ACM PANELS, SEE ELECTRICAL DRAWINGS AND DETAILS. 7 PRE-FABRICATED MECHANICAL EQUIPMENT SCREEN, SUPPLIED BY VENDOR, INSTALLED BY GC. REFER TO STRUCTURAL AND
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- 9 SERVICE/ TRASH ENCLOSURE; REF A410
- 10 SINGLE PLY ROOF MEMBRANE ON VERTICAL SURFACE OF WALL AS INDICATED, REF. B5/A601. 11 DIRECTION OF ACM PANEL FINISH AS INDICATED BY ARROW, TYP.
- EXTERIOR BUILDING LIGHT INSERTS IN ACM PANELS, SEE ELECTRICAL DRAWINGS AND DETAILS. 12 1/2" VERTICAL ACM REVEAL BY ACM PANEL MFR. FINISH TO MATCH ADJACENT PANEL FACE.

3" HORIZONTAL ACM REVEAL BY ACM PANEL MFR. FINISH TO BE BLACK.
ROOF AND OVERFLOW DRAIN PIPES IN THE WALL. TIE INTO STORM SYSTEM, REF. CIVIL


TYPE	MFR	DESCRIPTION	COLOR	NOTES	
40011-2000-20					
ACM PANEL ACM-01	ALPOLIC	ACM PANELS, ALPOLIC / PE	MBX METALLIC BRONZE	SUPPLIED BY	
ACM-01	ALFOLIO	AUM PANELS, ALPOLIU / PE	WIDA WETALLIO BRONZE	CENTURION/TFC CANOPY; REFER TO INTERIOR ELEVATIONS FOR INSTALL/GRAIN DIRECTION	
ACM-02	ALPOLIC	ACM PANELS, ALPOLIC / PE	JBR BRONZE	SUPPLIED BY CENTURION/TFC CANOPY; REFER TO INTERIOR ELEVATIONS FOR INSTALL/GRAIN DIRECTION	
CONCRETE M	MASONRY UNITS				
CMU-1	REGALSTONE CONCRETE BLOCKS	8" X 8" X 16" SMOOTH FINISH	CHARCOAL	OR APPROVED EQUAL	
CMU-2 REGALSTONE CONCRETE BLOCKS		8" X 8" X 16" SPLIT FACE FINISH	CHARCOAL	OR APPROVED EQUAL	
EIFS					
EF-01	DRYVIT	OUTSULATION PLUS MD, TERRANEO	WHITE		
EF-02	DRYVIT	OUTSULATION PLUS MD	#452ST STORMY NITE	SANDPEBBLE FINE FINISH	
27.02	- 21011)	001002111101112001110	a rocor e o o mar tarte	O MET COSCET MET MISH	
EXTERIOR PA	AINT	V		v-	
PT-01	SHERWIN WILLIAMS	URBANE BRONZE	SW7048		
METAL					
MT-01	EXCEPTIONAL METALS	PRE-FINISHED METAL COPING	DARK BRONZE		
MT-03	EXCEPTIONAL METALS	PRE-FINISHED METAL COPING/GRAVEL STOP	BONE WHITE		
MT-04	BERRIDGE	BRAKE METAL, 24 GA.	DARK BRONZE TO MATCH STOREFRONT FRAMING		
MT-05	BERRIDGE	FLUSH SEAM SOFFIT PANELS	HONEY WALNUT	JT	
MT-06	EXCEPTIONAL METALS	PRE-FINISHED METAL COPING/GRAVEL STOP	MEDIUM BRONZE		
MT-07	MAPES PANELS	MAPES SHAPES INFILL PANEL	DARK BRONZE TO MATCH STOREFRONT FRAMING		
MT-19	BY G.C.	1-1/2" GALVANIZED METAL DECKING, 22 GA.	PT-01		

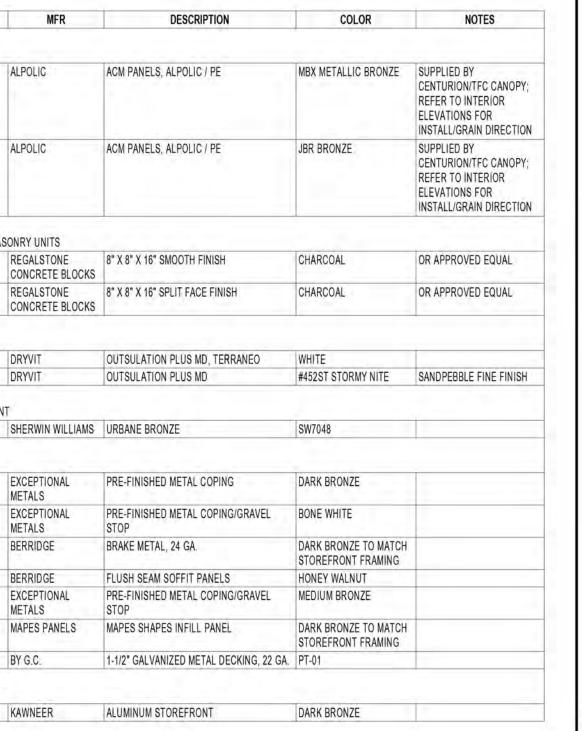

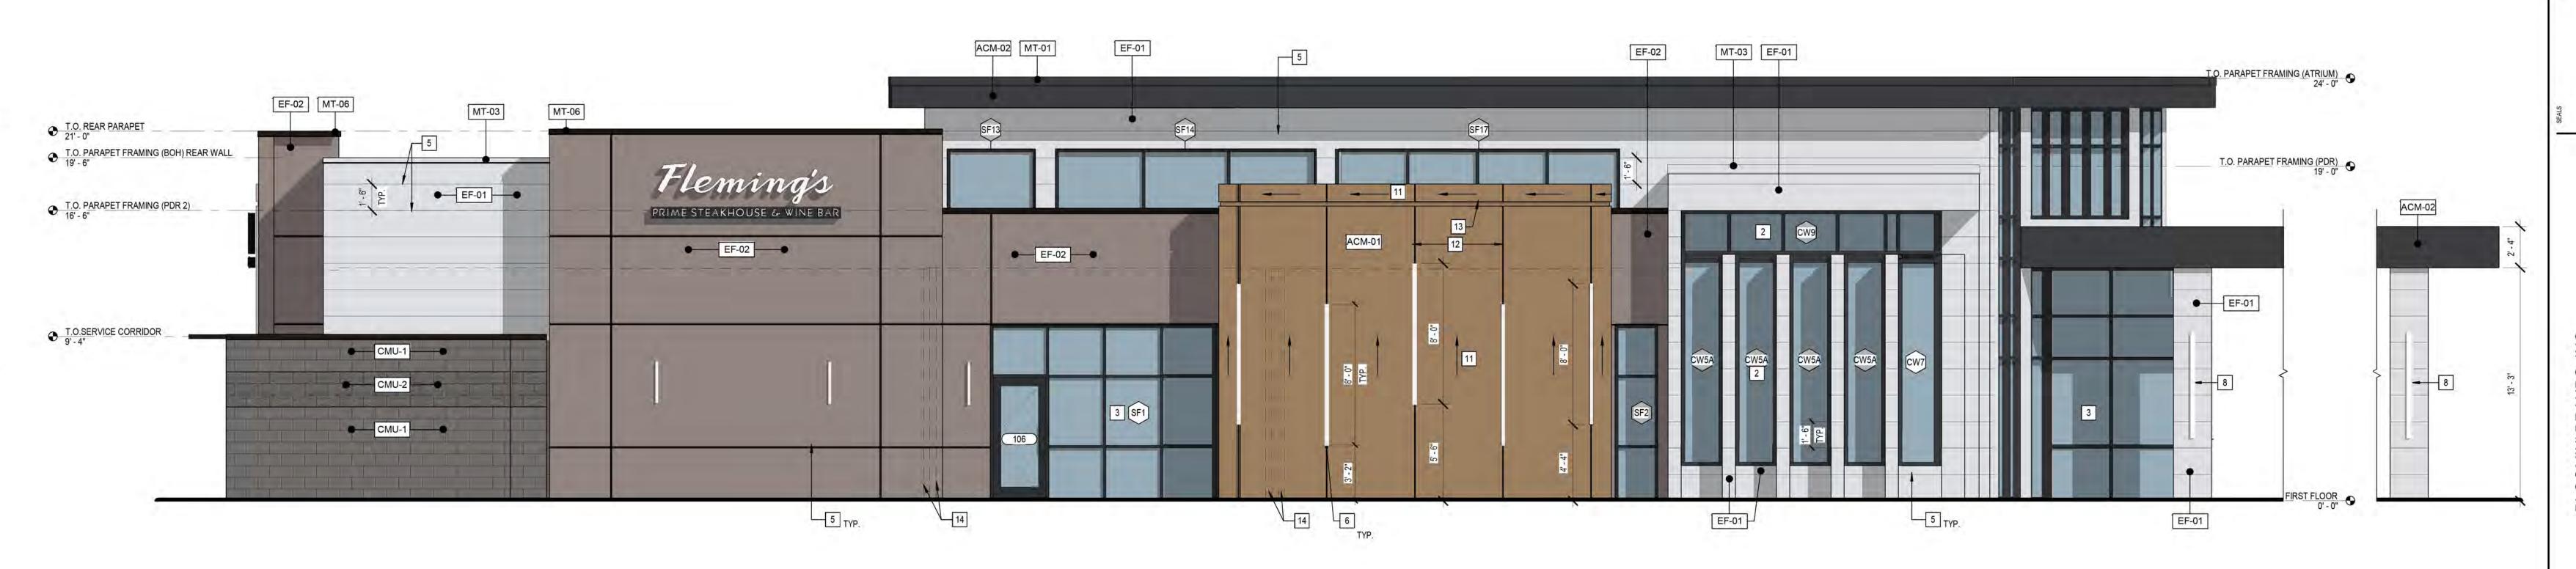

WEST ELEVATION (PDR SIDE)

1/4" = 1'-0"

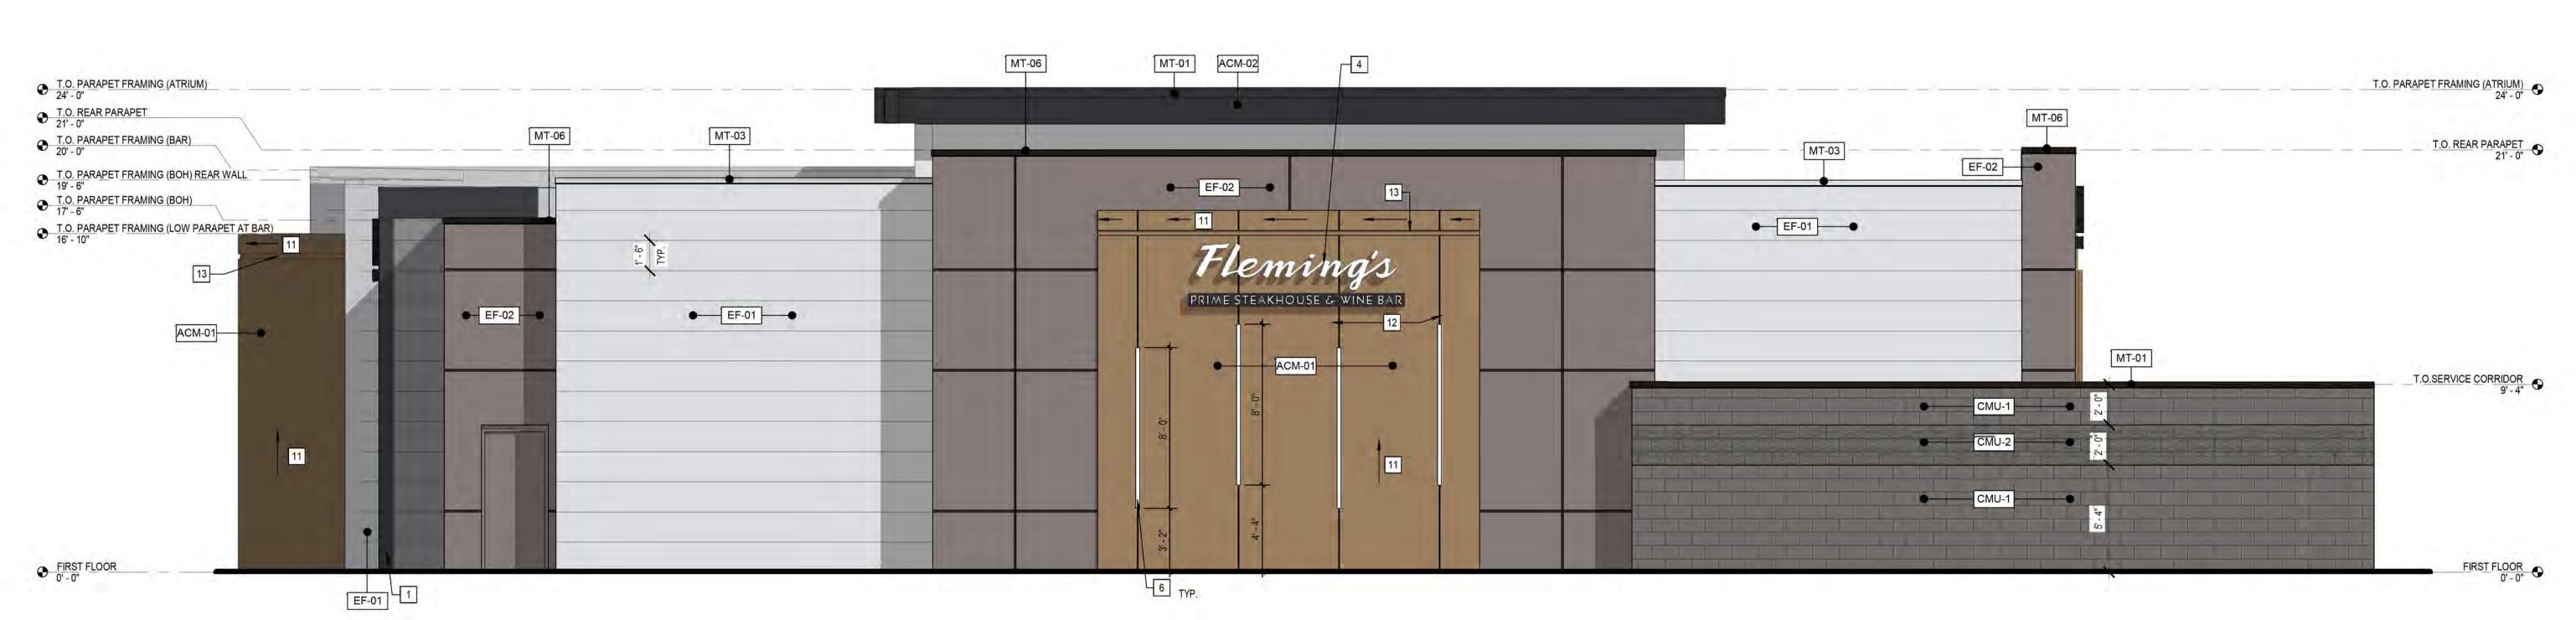

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520 South Main Street, Suite 2531 Akron, OH 44311 330.572.2100 Fax 330.572.2101

SHEET ISSUE:

PRINCIPAL IN CHARGE: PROJECT ARCHITECT: DRAWN BY:

EXTERIOR ELEVATIONS


PROJ. NO. 2023231.52 SHEET NO.

RO MS DS/ TB

NORTH ELEVATION (REAR SIDE)

1/4" = 1'-0"

A301

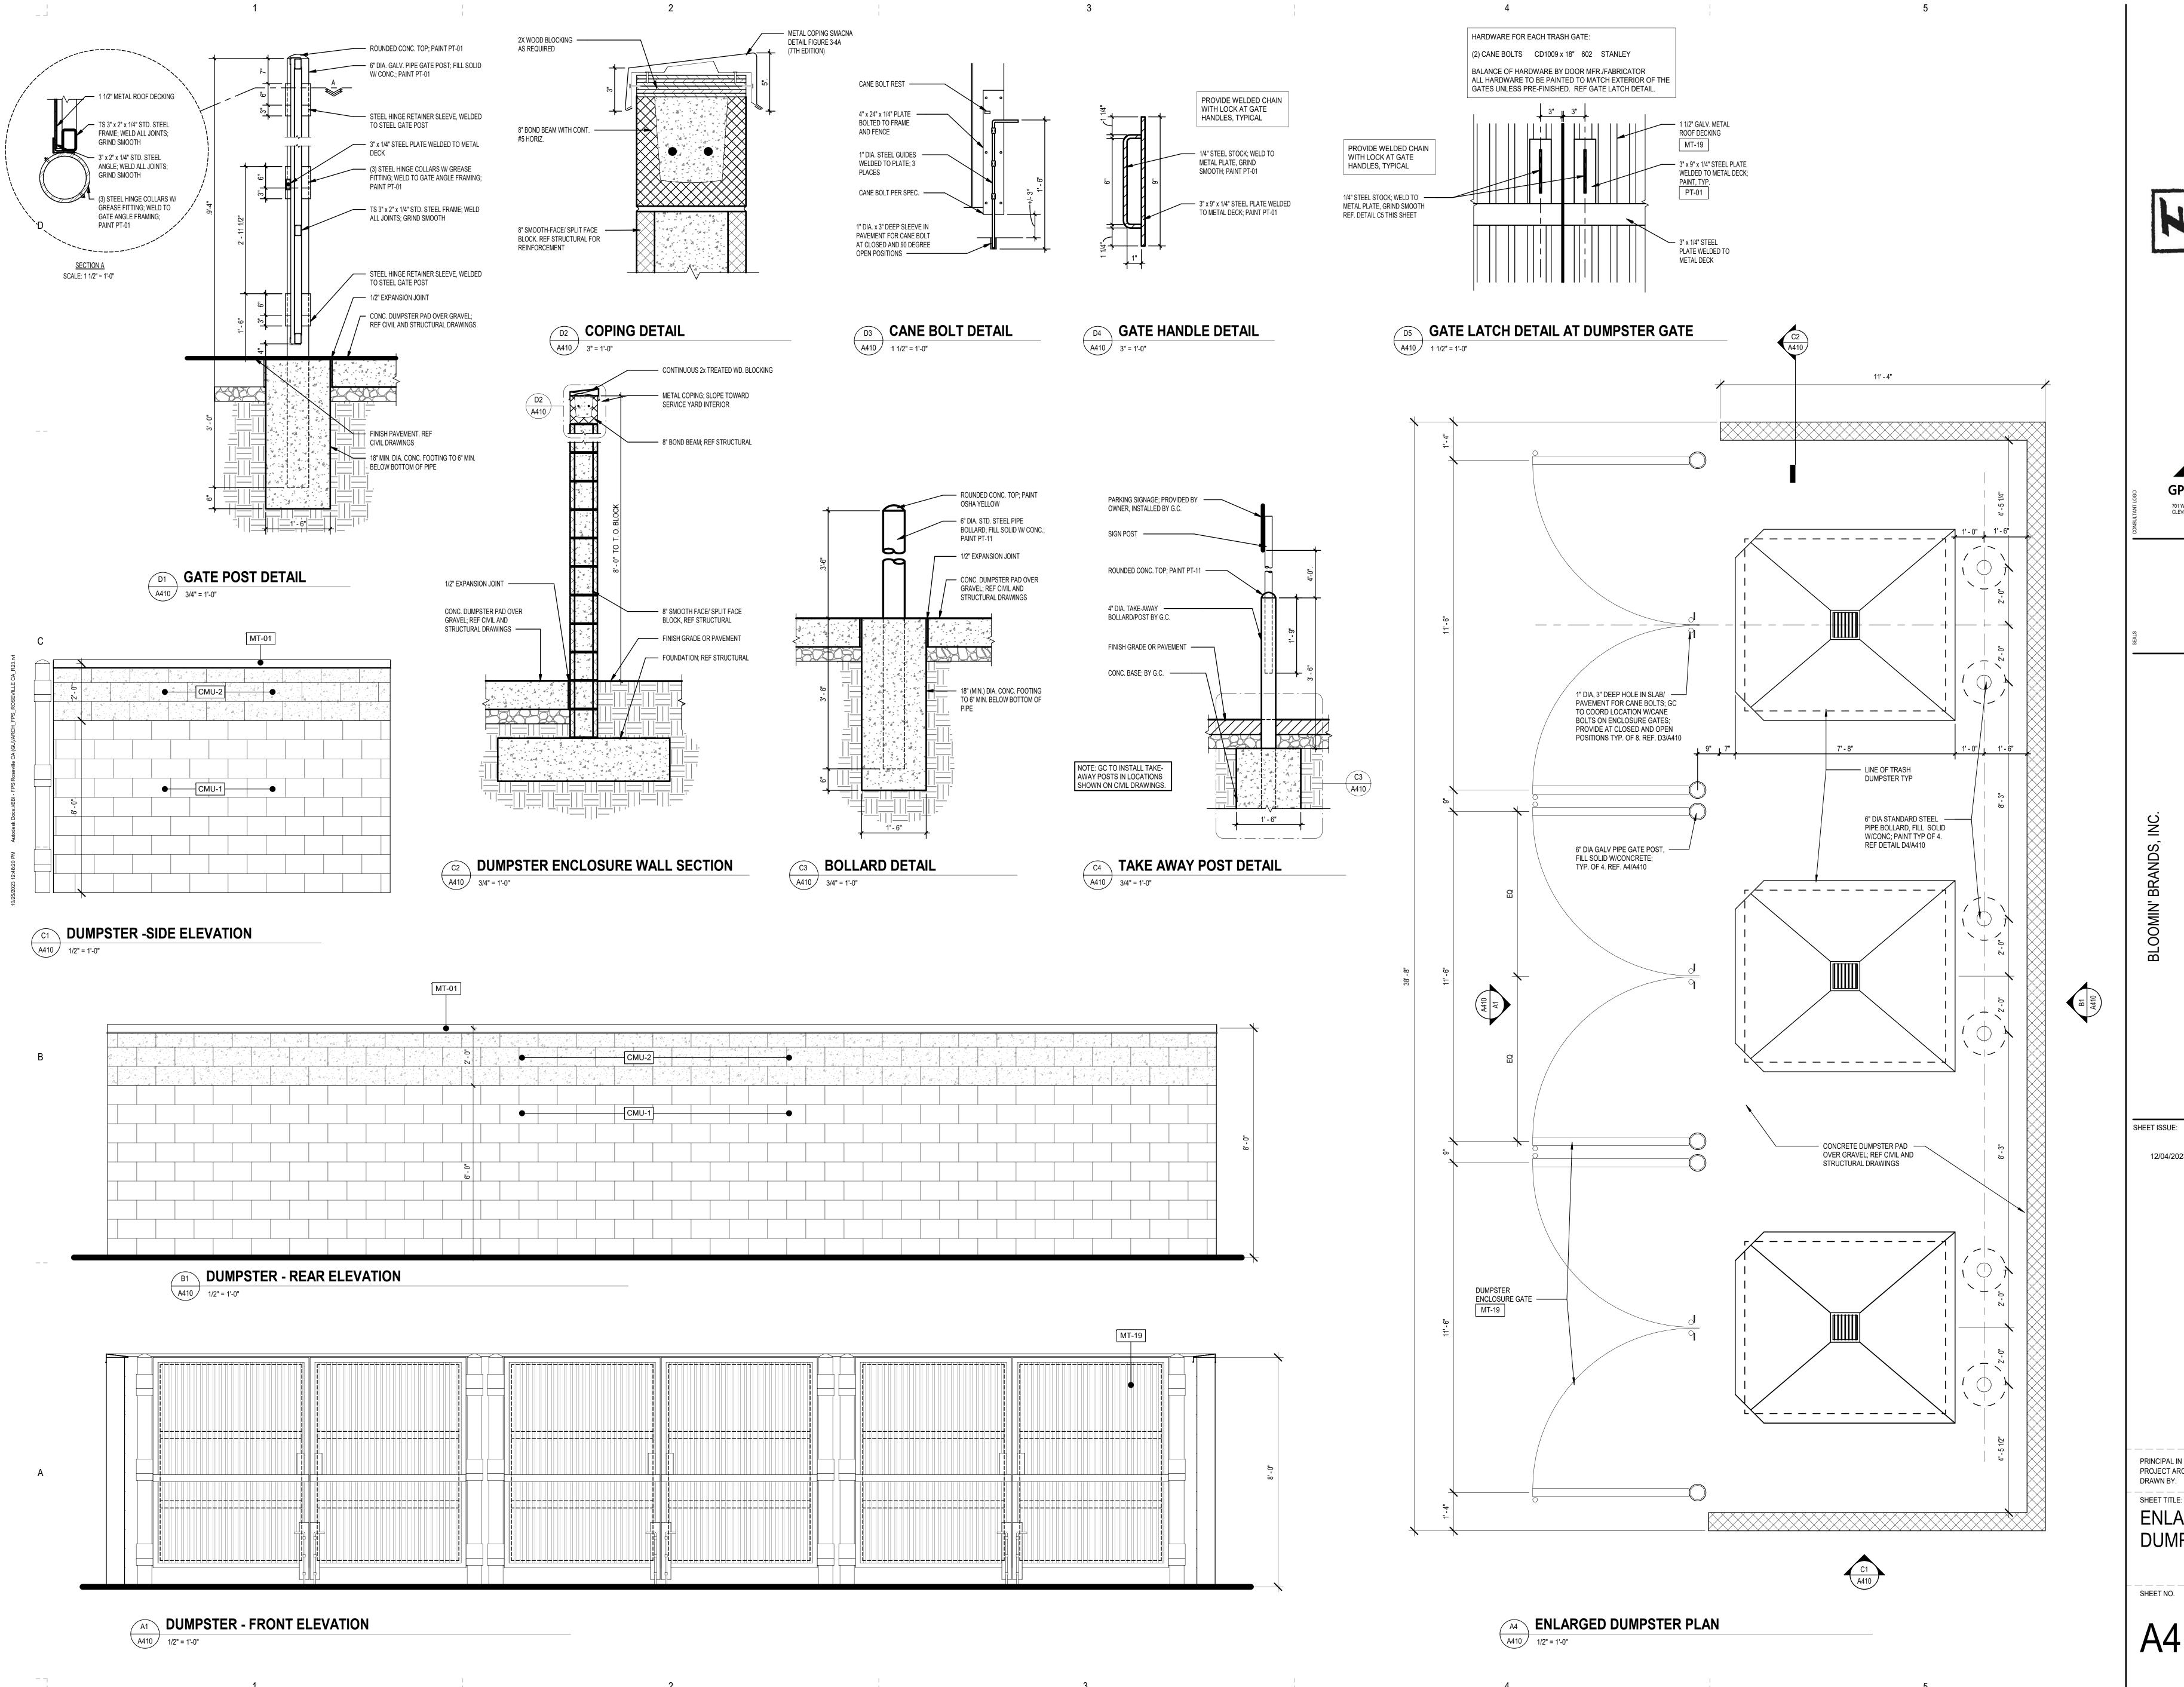





12/04/2023 ISSUED FOR PERMIT

PRINCIPAL IN CHARGE: PROJECT ARCHITECT:


ENLARGED DUMPSTER PLAN

> PROJ. NO. 2023231.52

CMU-1


DUMPSTER -SIDE ELEVATION

A410 1/2" = 1'-0"

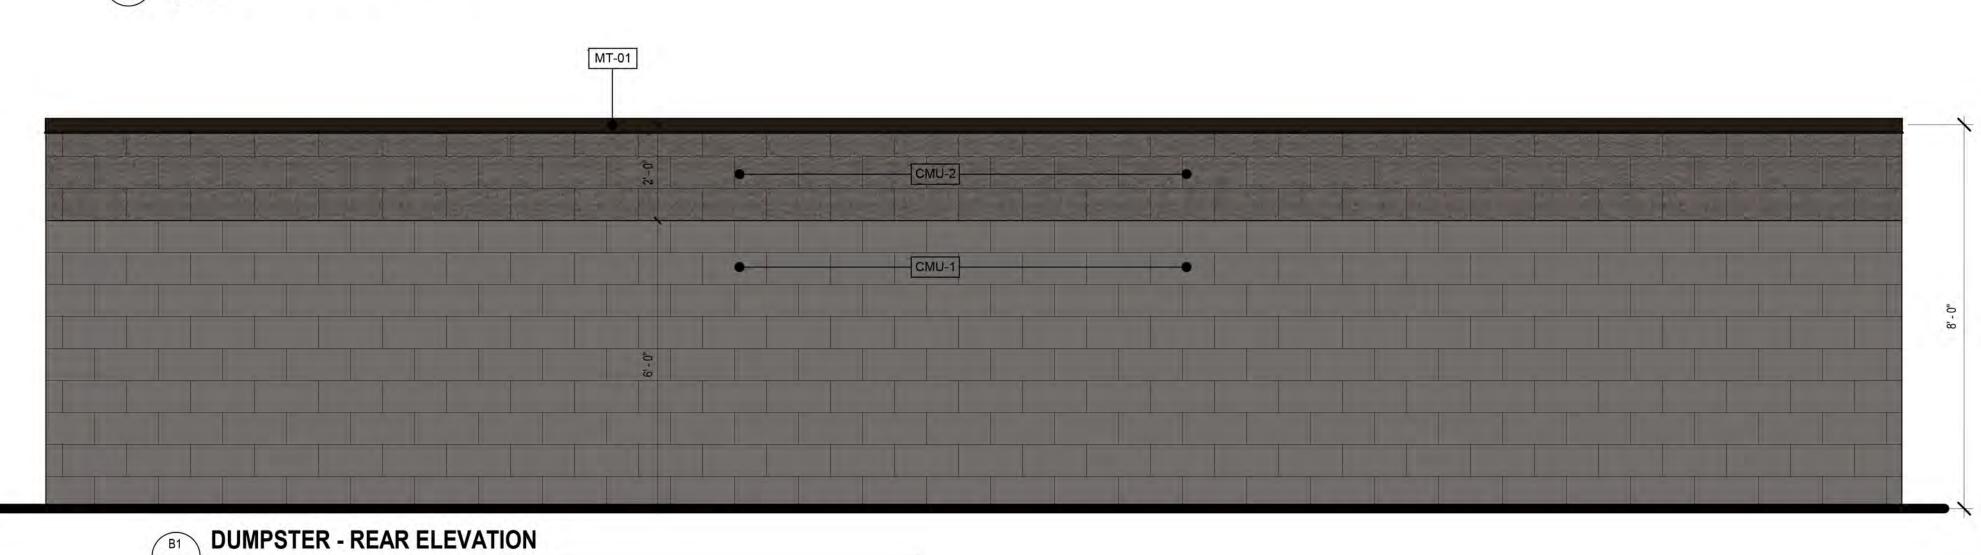

DUMPSTER - FRONT ELEVATION

1/2" = 1'-0"

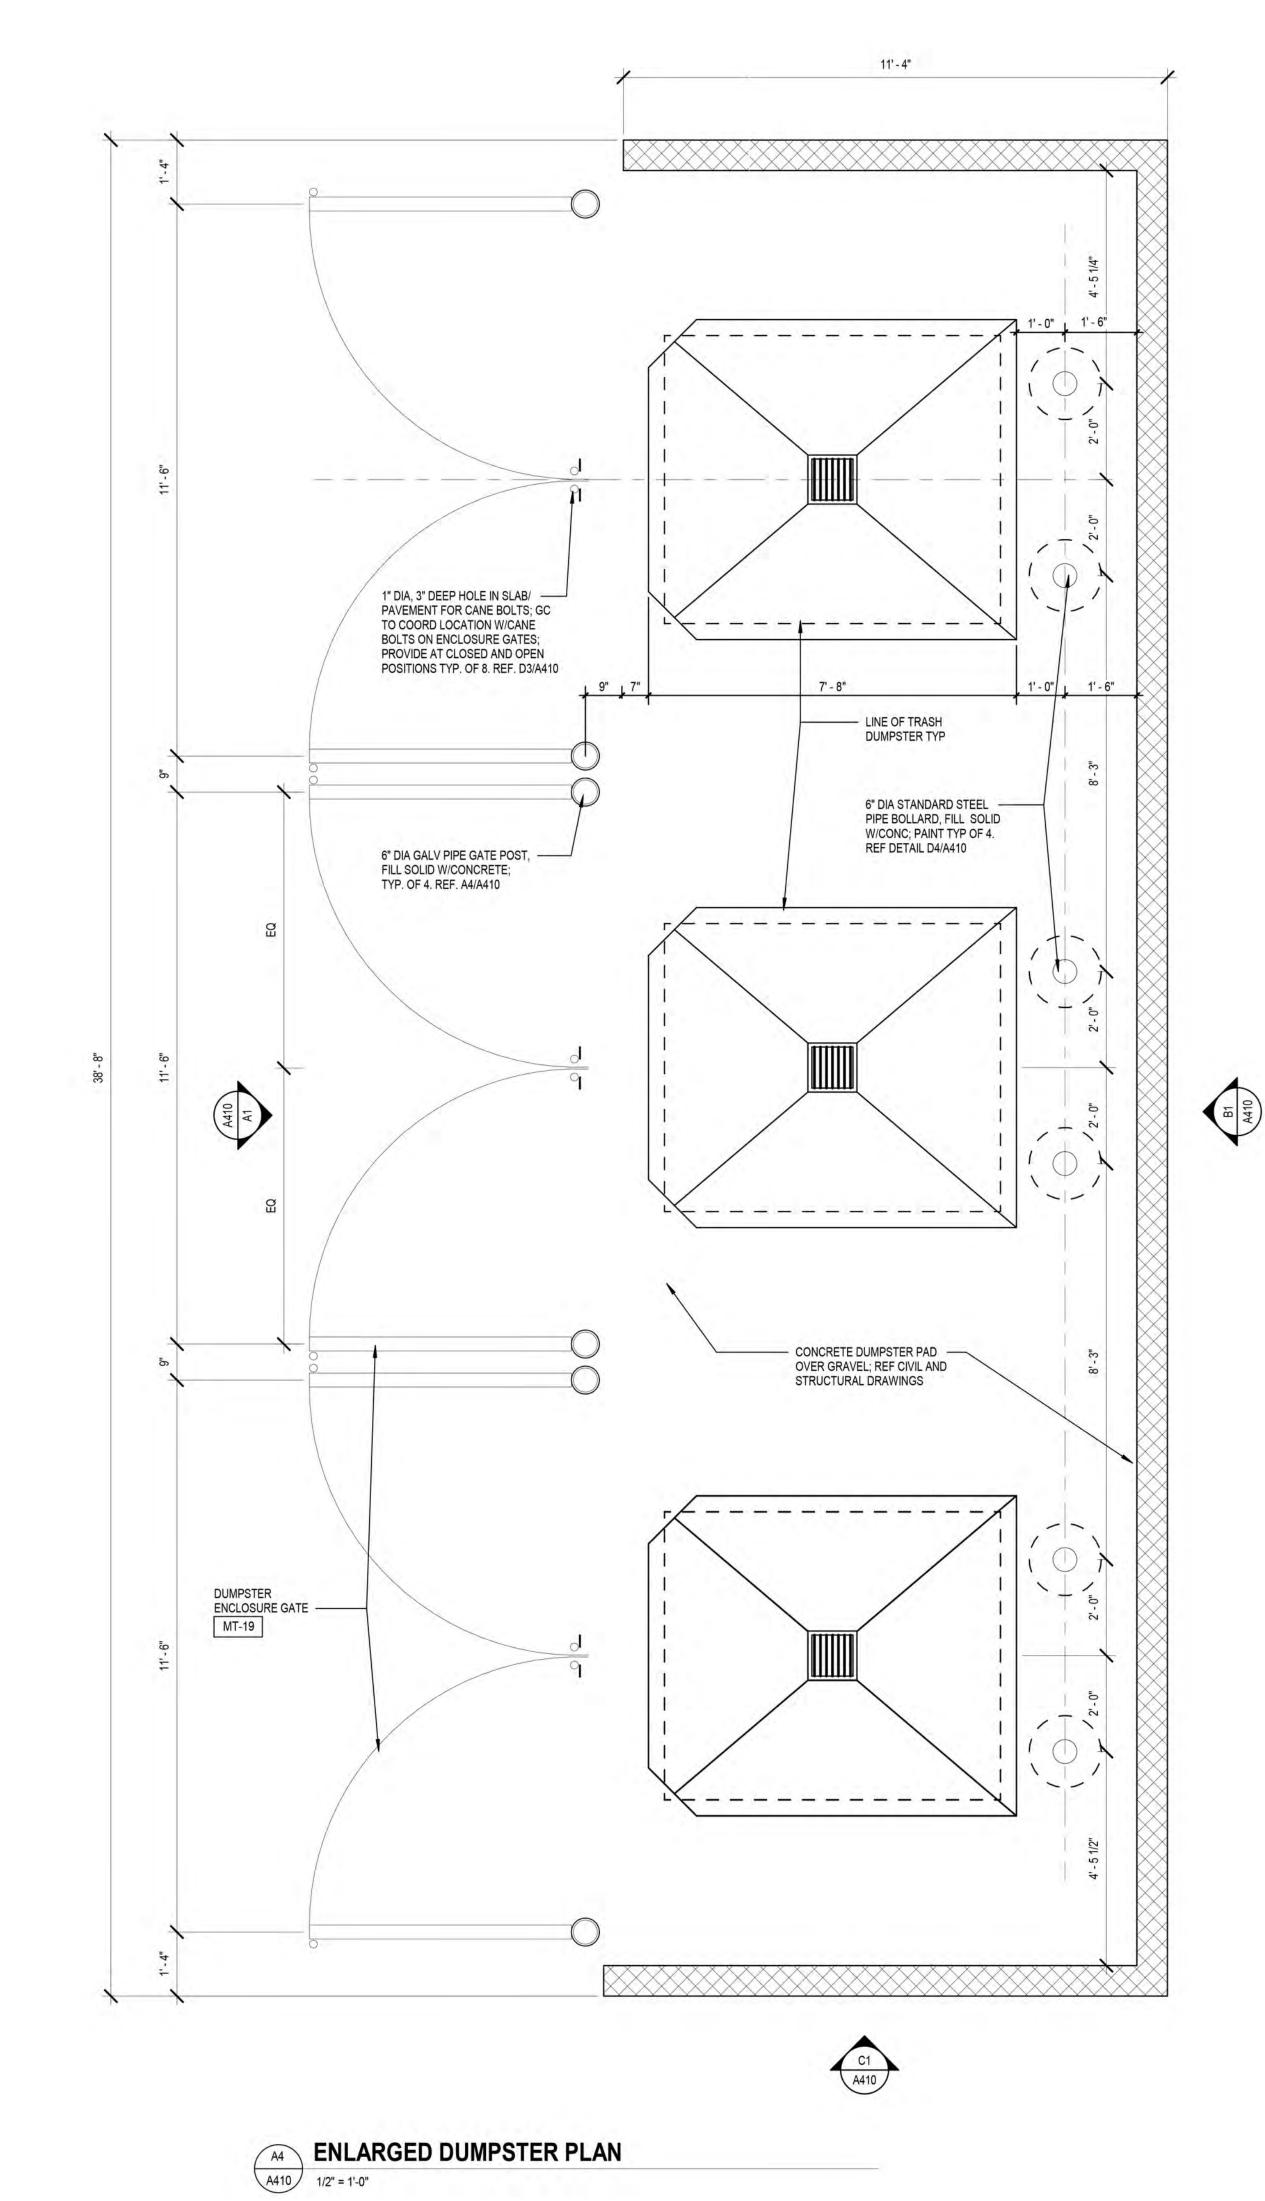



SHEET ISSUE:


12/04/2023 ISSUED FOR PERMIT

PRINCIPAL IN CHARGE: PROJECT ARCHITECT: DRAWN BY:

SHEET TITLE: **ENLARGED DUMPSTER PLAN**

PROJ. NO. 2023231.52

A410

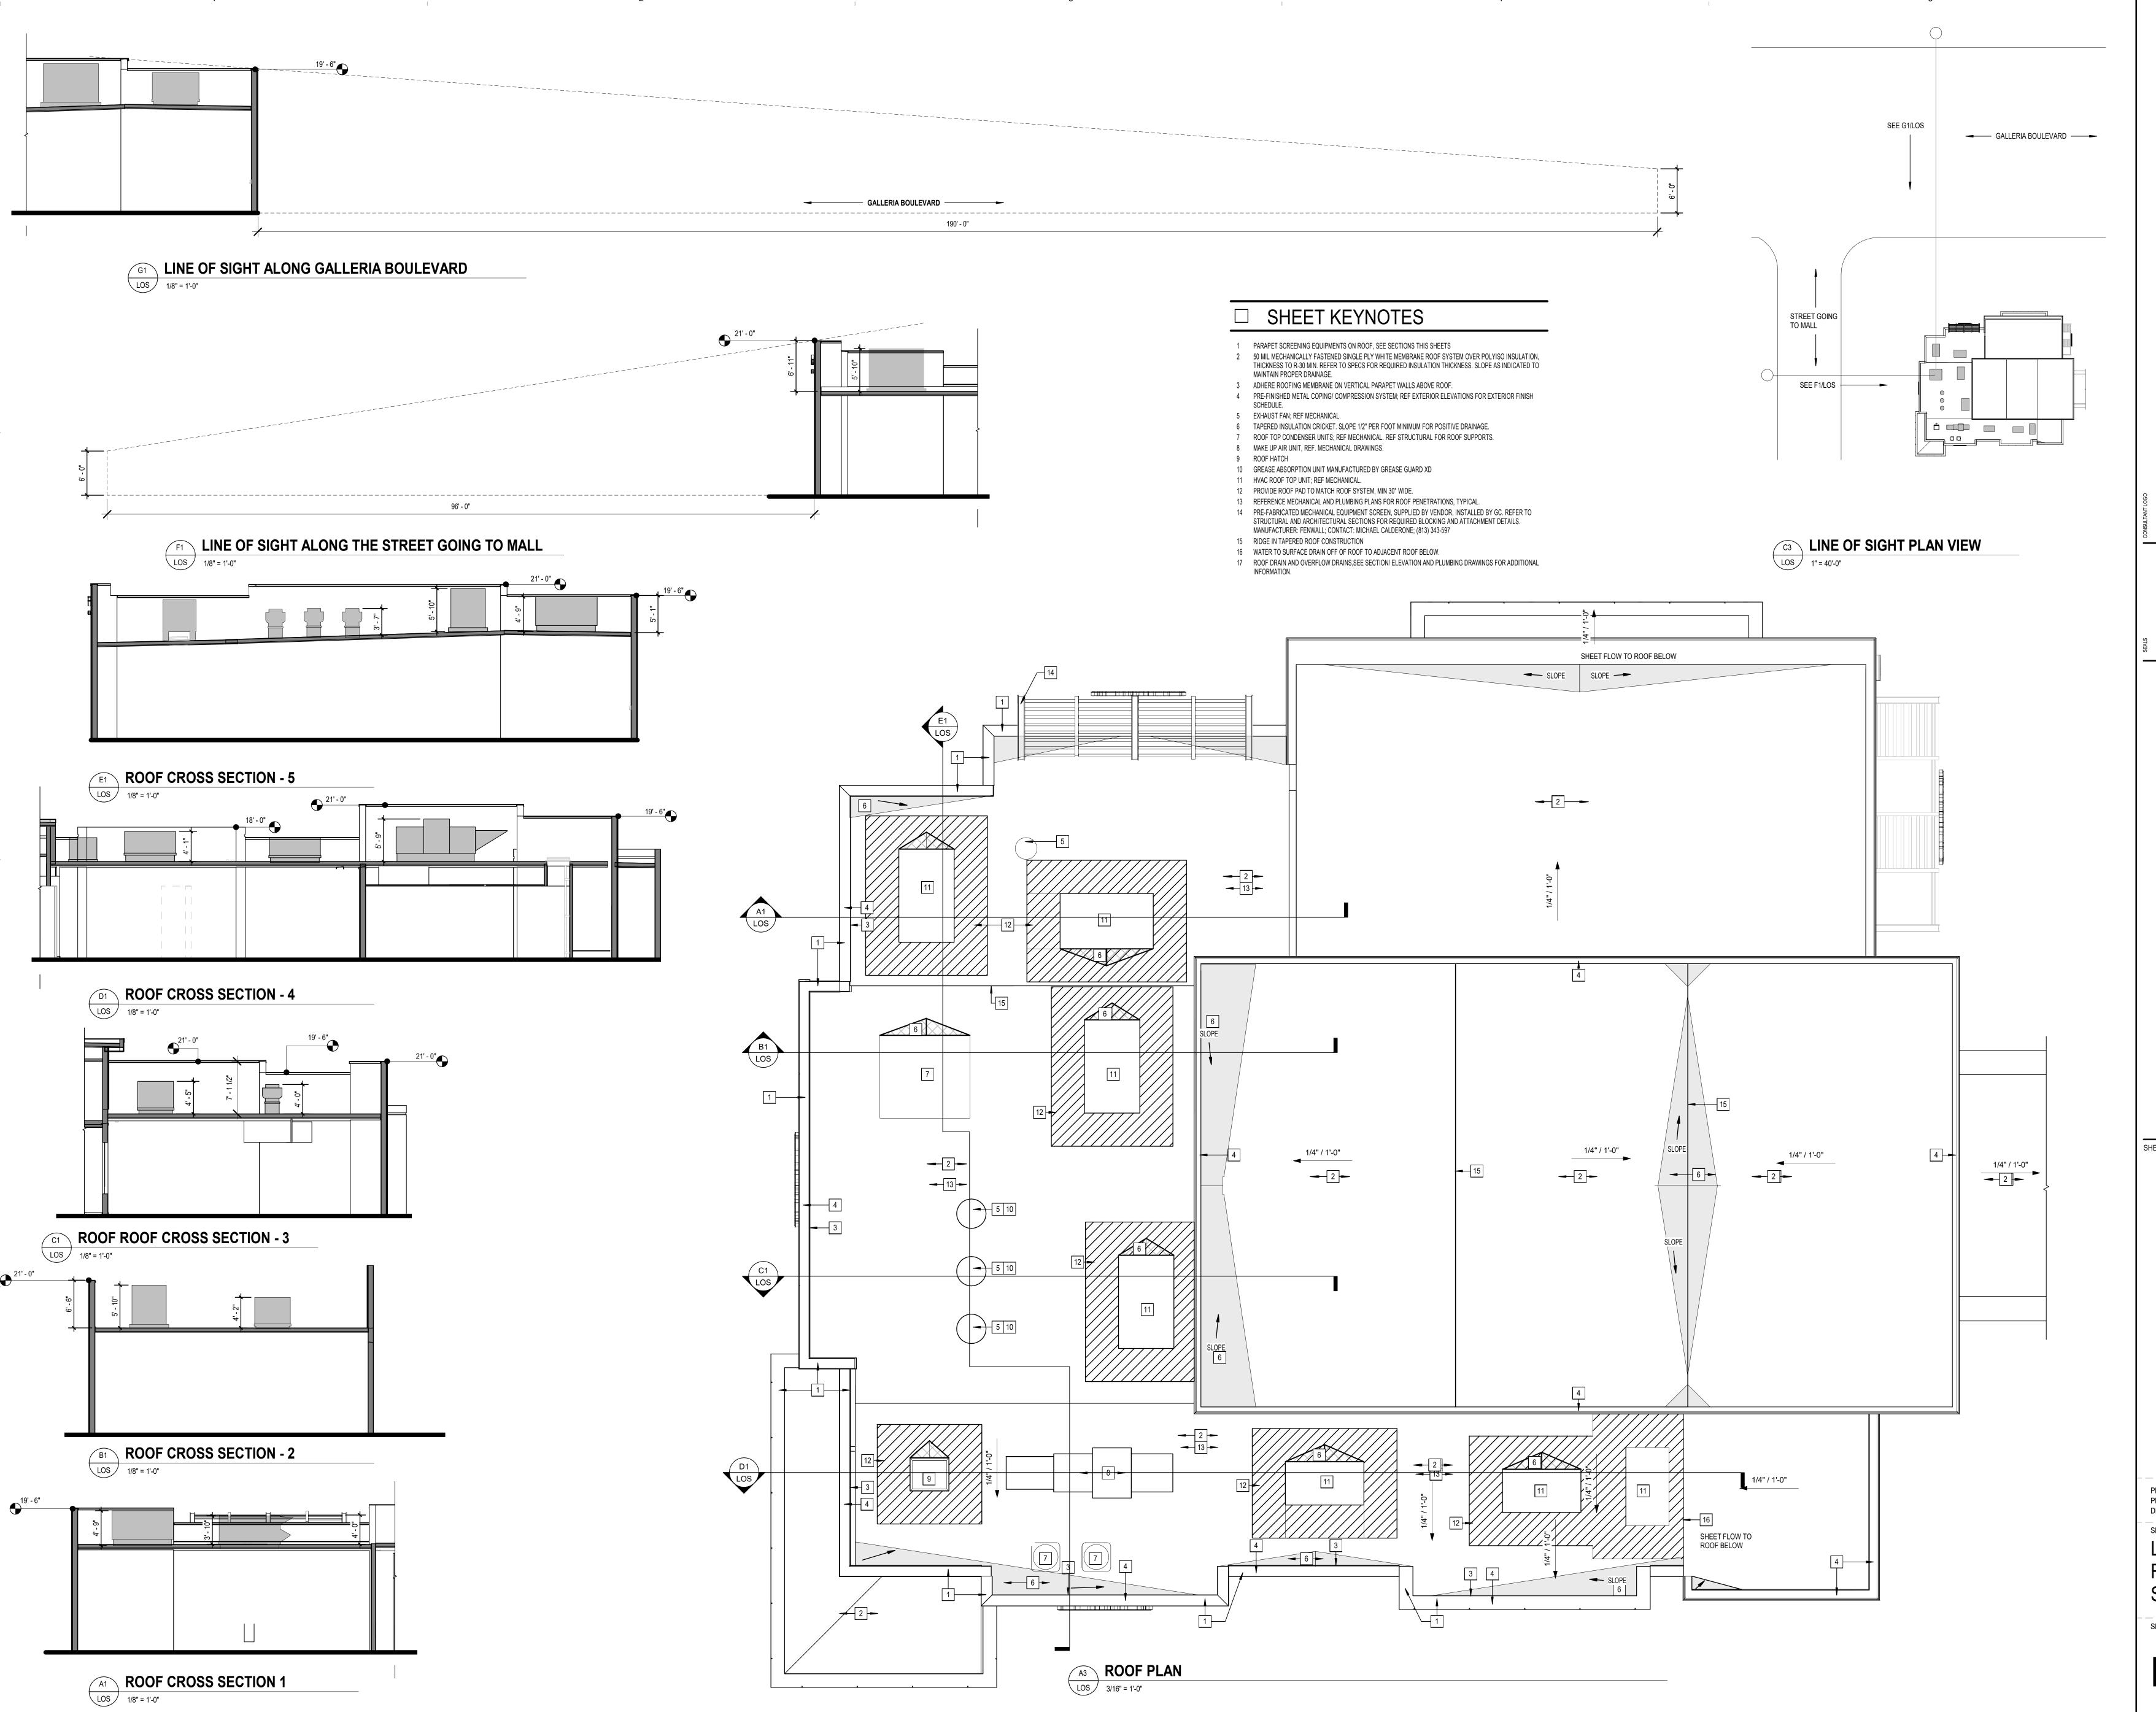





FLEMING'S PRIME STEAKHOUSE

SHEET ISSUE:

08/11/2023 SITE PLAN SUBMITTAL

PRINCIPAL IN CHARGE:
PROJECT ARCHITECT:
DRAWN BY:

SHEET TITLE:

LINE OF SIGHT
ROOF EQUIPMENT

SCREENING

PROJ. NO. 2023231.52


SHEET NO.


LOS

Calculation Summary						
Label	Units	Avg	Max	Min	Avg/Min	Max/Min
PROPERTY LINE	Fc	0.53	2.4	0.0	N.A.	N.A.
SITE	Fc	1.19	5.0	0.0	N.A.	N.A.

Luminaire S	chedule				
Symbol	Label	Qty	Part Number	Description	
—	P1	1	RSX2 LED P5 40K R3 MVOLT IS DDBXD	NEW LIGHT/EXISTING POLE	
	P2	2	RSX2 LED P5 40K R5 MVOLT MA DDBXD	NEW LIGHT/EXISTING POLE	

- DUE TO CHANGING LIGHTING ORDINANCES IT IS THE CONTRACTORS RESPONSIBILITY TO SUBMIT THE SITE PHOTOMETRICS AND LUMINAIRE SPECS TO THE LOCAL INSPECTOR BEFORE ORDERING TO ENSURE THIS PLAN COMPLIES WITH LOCAL LIGHTING ORDINANCES
- THIS LIGHTING DESIGN IS BASED ON INFORMATION SUPPLIED BY OTHERS. CHANGES IN ELECTRICAL SUPPLY, AREA GEOMETRY AND OBJECTS WITHIN THE LIGHTED AREA MAY PRODUCE ILLUMINATION VALUES DIFFERENT FROM THE PREDICTED RESULTS SHOWN ON THIS LAYOUT.
- THIS LAYOUT IS BASED ON IES FILES THAT WERE LAB TESTED OR COMPUTER GENERAGED. ACTUAL RESULTS MAY VARY

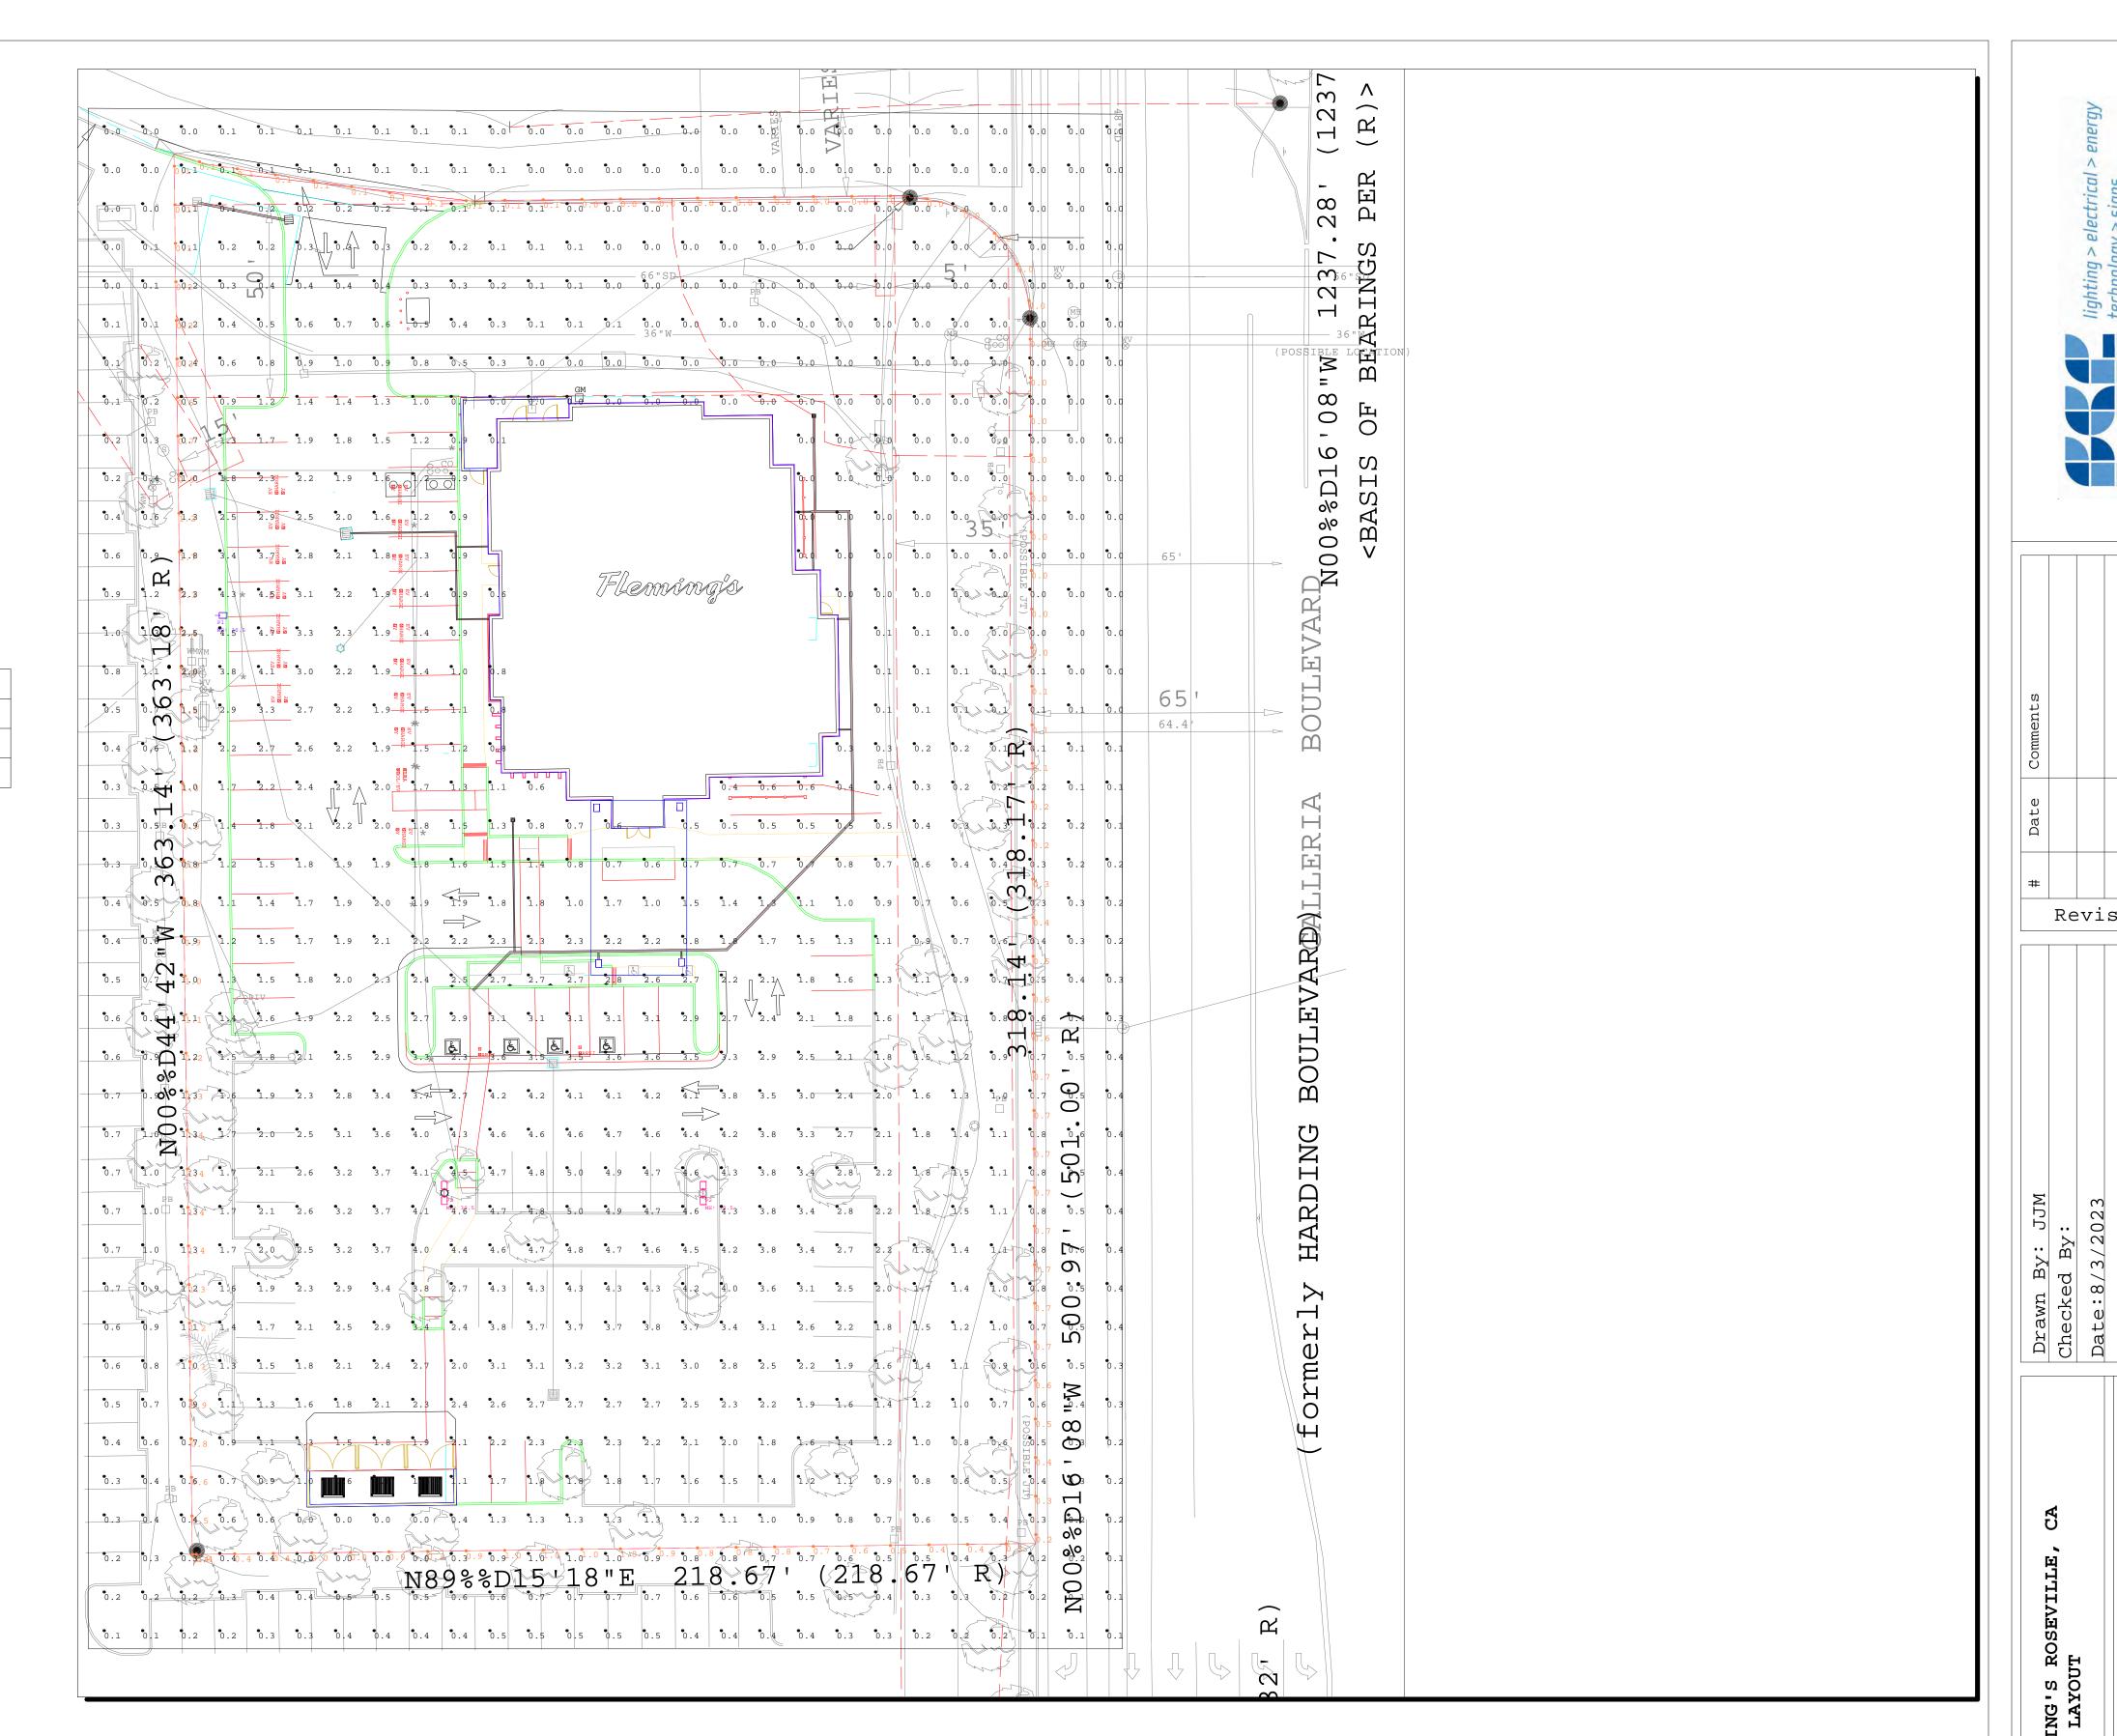

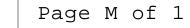

Revisions