

2016 CALIFORNIA GREEN BUILDING CODE

NON-RESIDENTIAL MANDATORY MEASURES

Method of Compliance Verification (MCV) shown below measures

**SECTION 5.401 MATERIAL CONSERVATION/RESOURCE EFFICIENCY**  
**5.401.1 Scope.** The provisions of this chapter shall outline means of achieving material conservation and resource efficiency through protection of buildings from exterior moisture, construction waste diversion, employment of techniques to reduce pollution through recycling of materials, and building commissioning or testing and adjusting. MCV: Where applicable the requirements of this section shall be documented on the plans; completion of necessary compliance forms and results of required special inspections shall be provided to the Building Inspection Division prior to issuance of Certificate of Occupancy.

**SECTION 5.501 ENVIRONMENTAL QUALITY**  
**5.501.1 Scope.** The provisions of this chapter shall outline means of reducing the quantity of air contaminants that are odorous, irritating, and/or harmful to the comfort and well-being of a building's installers, occupants and neighbors. MCV: General Contractor shall retain material data sheets for products provided under this section for on-site verification.

**5.504.4.1 Adhesives, sealants and caulks.** Adhesives, sealants, and caulks used on the project shall meet the requirements of the following standards:  
1. Adhesives, adhesive bonding primers adhesive primers, sealants, sealant primers and caulks shall comply with local or regional air pollution control or air quality management district rules where applicable, or SCQMD Rule 1168VOC limits, as shown in Tables 5.504.4.1 and 5.504.4.2. Such products also shall comply with the Rule 11 68 prohibition on the use of certain toxic compounds (chloroform, ethylene dichloride, methylene chloride, perchloroethylene and trichloroethylene), except for aerosol products as specified in subsection 2, below.  
2. Aerosol adhesives, and smaller unit sizes of adhesives, and sealant or caulking compounds (in units of product, less packaging, which do not weigh more than one pound and do not consist of more than 16 fluid ounces) shall comply with statewide VOC standards and other requirements, including prohibitions on use of certain toxic compounds, of California Code of Regulations, Title 17, commencing with Section 94507.  
**5.504.4.3 Paints and coatings.** Architectural paints and coatings shall comply with VOC limits in Table 1 of the ARB Architectural Coatings Suggested Control Measure, as shown in Table 5.504.4.3, unless more stringent local limits apply. The VOC content limit for coatings that do not meet the definitions for the specialty coatings categories listed in Table 5.504.4.3 shall be determined by classifying the coating as a Flat, Nonflat or Nonflat-High Gloss coating, based on its gloss, as defined in Subsections 4.21, 4.36 and 4.37 of the 2007 California Air Resources Board, Suggested Control Measure, and the corresponding Flat, Nonflat or Nonflat-High Gloss VOC limit in Table 5.504.4.3 shall apply.

**5.504.4.3.1 Aerosol paints and coatings.** Aerosol paints and coatings shall meet the PWMIR Limits for ROC in Section 94522(a)(3) and other requirements, including prohibitions on use of certain toxic compounds and ozone depleting substances, in Sections 94522(c)(2) and (d)(2) of California Code of Regulations, Title 17, commencing with Section 94520; and in areas under tile jurisdiction of the Bay Area Air Quality Management District additionally comply with the percent VOC by weight of product limits of Regulation 8 Rule 49.


**5.504.4.5 Composite wood products.** Hardwood plywood, particleboard and medium density fiberboard composite wood products used on the interior or exterior of the building shall meet the requirements for formaldehyde as specified in the ARB's Air Toxics Control Measure for Composite Wood (17 CCR 93120 et seq.) Those materials not exempted under ATCM must meet the specified emission limits, as show in table 5.540.4.5.

**7022 Special Inspection [HCD]** When required by the enforcing agency, the owner or the responsible entity acting as the owner's agent shall employ one or more special inspectors to provide inspection or other duties necessary to substantiate compliance with this code. Special inspectors shall demonstrate competence to the satisfaction of the enforcing agency for the particular type of inspection or task to be performed and shall be independent entities with no financial interest in the materials or the project that they are inspecting for compliance with this code.

WASTE MANAGEMENT

Submit a Waste Management Plan by email to [SCST@Roseville.ca.us](mailto:SCST@Roseville.ca.us) or by fax to 916-774-5798. And that if you have questions or need assistance completing a Waste Management Plan, that you will call 916-774-5780.

VICINITY MAP

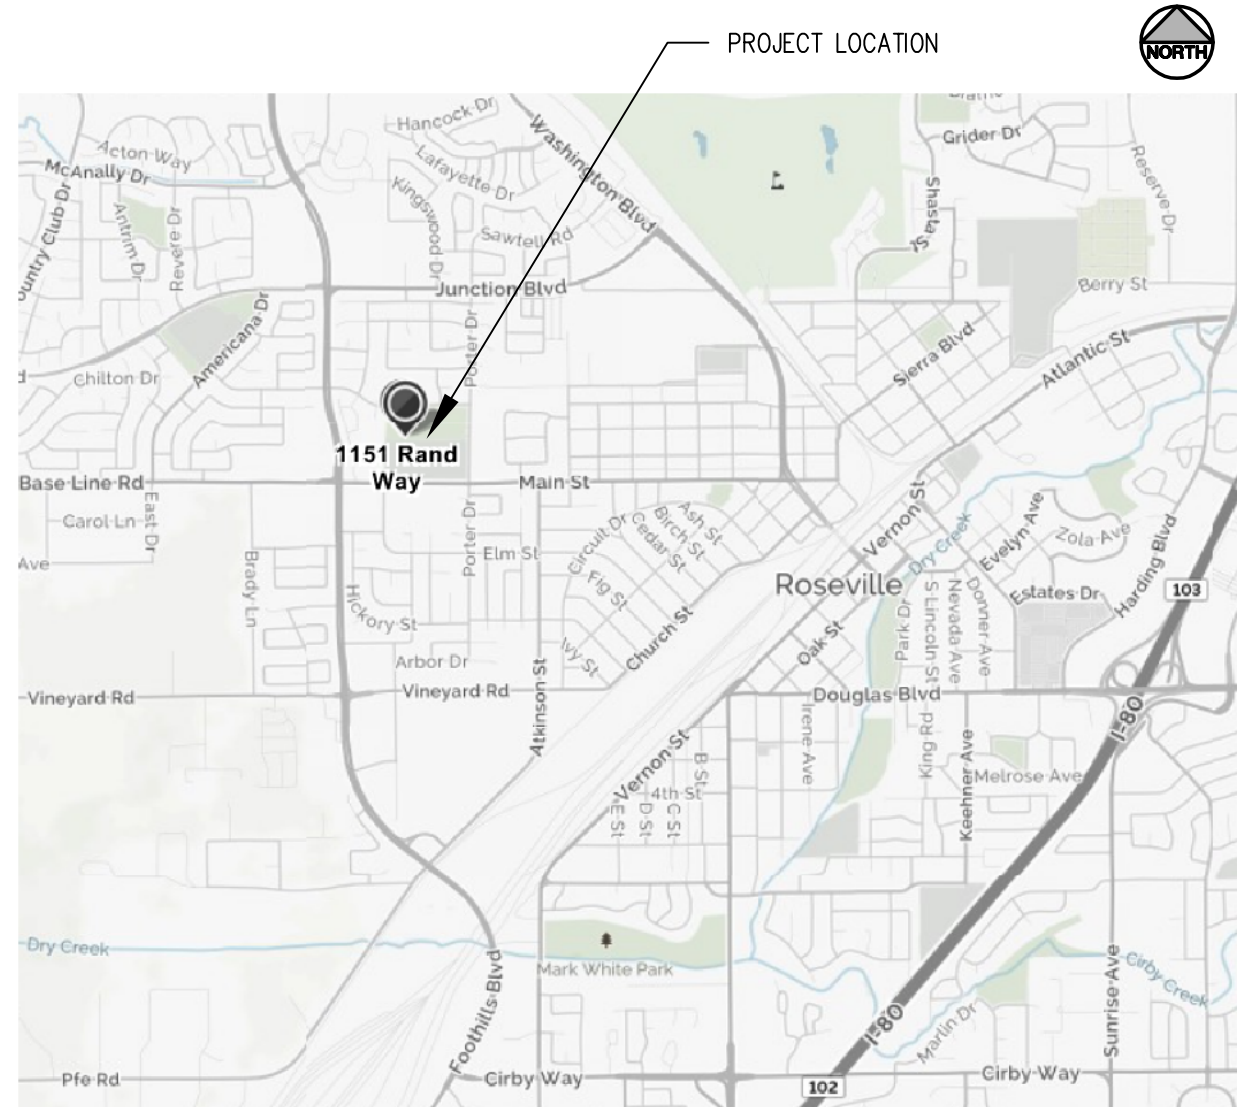

ABBREVIATIONS

ABV. @ A/C ACOUS. A.D.A. ADJ. AOG. AL.  BD. BETW. BLDG. BLK. BLCK. BM. BOT.  CA CAB. C.B. C.B.C. C.E.C. C.E.C. C.F.C. C.M.C. C.P.C.	ASOVE AND AIR CONDITIONING ACOUSTICAL AMERICANS WITH DISABILITIES ACT ADJUSTABLE AGGREGATE ALUMINUM  BOARD BETWEEN BUILDING BLOCK BLOCKING BEAM BOTTOM  CALIFORNIA CABINET CEILING BREAK CA BUILDING CODE CA ELECTRICAL CODE CA ENERGY CODE CA FIRE CODE CA MECHANICAL CODE CA PLUMBING CODE	C.E.M. C.F.R. C.L. C.L.C. CONC. C.M.U. CONJ. CONT. C.U.  DEMOLITION DET. D.I.M. D.I. Ø D.B.L. D.F. DN. DR. DRAIN D.V. DW  (E) or EXIST. EAST EA. E.D.F.  E.J. ELEV. EQ. EXH. EXT.	CEMENT CENTERLINE CEILING CLEAR CONCRETE CONC. MASONRY UNIT CONNECTION CONTINUOUS CONTROL JOINT  DEMOLITION DETAIL DIAMETER DRAIN INLET DIAMETER OR ROUND DOUBLE DOUGLAS FIR DOWN DOOR DOWNSPOUT DRYER VENT DISHWASHER  EXISTING EAST EACH ELECTRIC DRINKING FOUNTAIN EXPANSION JOINT ELEVATION HORIZONTAL EXHAUST EXTERIOR	F.H.W.S. F.E. F.B. GL. F.IN. F.F. FL. F.M.B. FLASH. F.LOR. F.O.B. FT. FURR. F.U.R.P.  GA. GALV. G.B. GD GL GLU-LAM G.L.B. GY.P.  H.B. HANDCAPPED HDR. HDWD. HT. EQ. HR. H.W. H.R.	FLAT HEAD WOOD SCREW PIPE EXTINGUISHER FIBERGLASS FINISH FINISH FLOOR FLOOR FLOOR MAT'L BREAK FLASHING FLUORESCENT FACE OF BLOCK FOOT OR FEET FOOTING FURRING FIBERGLASS REINFORCED PLASTIC  GANGE GALVANIZED GRAB BAR GARBAGE DISPOSAL GALVANIZED IRON GLASS GLUE LAMINATED GLU-LAM BEAM GYPSUM  H.O.S.E HANDCAPPED HEADER HARDWOOD HEIGHT HORIZONTAL HOUR HOT WATER HAND RAIL.	INT. IN. INSUL.  JAN. JST.  IB, # LAM-PLAS. LAV.  M.T.L. MAX. MECH. MET M.F.P. MIN. MISC. MOIST. M.S. MW. M.T.  (N) N. N/A N.F.V.A NFC N.D. NOM. N.T.S.	INTERIOR INCHES INSULATION  JANITOR JOIST  P.O.U.N.D LAMINATED PLASTIC LAVATORY  MATERIAL MAXIMUM MECHANICAL METAL MANUFACTURER MINIMUM MISCELLANEOUS MOISTURE MOISTURE BARRIER MICROWAVE OVEN METAL THRESHOLD  NEW NORTH NOT APPLICABLE NET FREE VENT AREA NOT IN CONTRACT NUMBER NOMINAL NOT TO SCALE	O.C. O.D. OPP.  OV. OV.  P.L. P.L.V. PLAS. P.M.F. P.W.D. PR. P.T.  R.W.L. R/A RAD US REINFORCED REQ RES. RM. R.O. R.W.D. REF. R/S	ON CENTER OUTSIDE DIAMETER OPPOSITE  OVER OVEN  PLYWOOD PLASTER PRESSED METAL FRAME PLYWOOD FAIR PRESSURE TREATED  RETURN AIR RAD US REINFORCED REQUIRED RESISTANT ROOM ROUGH OPENING REDWOOD REFRIGERATOR RUFF-SAWN	S.L. S.P. S.Q. STD. SUPPLY AIR SUSP.  TEL. T&G THK TPD TS TYP.  U.B.C. U.N.O.  VAL. VERT.  WAINS. W WD. W/O W.H. W.P. YD.	SLOPE STRUCTURAL PLYWOOD SQUARE STANDARD SUPPLY AIR SUSPENDED  TELEPHONE TONGUE AND GROOVE THICK TOILET PAPER DISPENSER TUBE STEEL TYPICAL (AT ALL SIMILAR CONDITIONS)  UNIFORM BUILDING CODE UNLESS NOTED OTHERWISE  VALLEY VERTICAL  WAINSOT WEST OR WATER W/TH WOOD W/TH-OUT WATER HEATER WATERPROOF WELDED WIRE FABRIC  YARD
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GENERAL NOTES AND REQUIREMENTS

- A. CODE COMPLIANCE**
- All materials and workmanship shall comply with the latest editions of the California Building Code and all other applicable Codes and Local Ordinances.
  - Contractors shall be familiar with all building codes, regulations and local ordinances having jurisdiction over this project and shall notify architect of any discrepancies prior to proceeding with any work affected by the discrepancy.
- B. CONTRACTUAL**
- The Work of the contract shall include all work indicated on the Drawings or Specifications (Contract Documents) which falls within the general construction limits as defined on the drawings and any work outside the general construction lImTs noted or otherwise Indicated as part of the contract.
  - The General Contractor shall clarify in the Construction Contract the extent of sitework that is or is not included in the construction contract. The contract shall identify specifically the extent of driveway, patio slab work, decking, Site drainage systems, landscaping and irrigation systems, etc. that are included in the contract.
  - The Construction Contract shall clearly identify any work that shall be completed or paid separately for by the Owner.
  - All materials shall be new, of grades and types specified and shall be guaranteed for one year from notice of completion.
- C. ARCHITECTURAL CONTROL**
- Any diversion from the drawings or specifications shall require the approval of the Architect prior to commencing with the modification.
  - The Architect reserves the copyright to all drawings and designs. The drawings shall not be reused for any site location other than the one specified here without the approval of the Architect.
- D. CONTRACTOR RESPONSIBILITIES**
- Contractor shall investigate, verify and be responsible for all conditions and dimensions of the project and shall notify Owner of any condition requiring modification or change before proceeding with the work.
  - Contractor shall visit the Bite to verify site conditions --- topography, location of utilities, vegetation, existing structures, easements, dimensions --- prior to submitting a construction bid.
  - Each Contractor shall furnish all labor, materials, tools, transportation and equipment necessary to perform all work under his trade in full accordance with the Contract Documents and Contracts.
  - Each contractor shall clean up debris resulting from his work.
- E. DIMENSION AND MISC.DRAWING REQUIREMENTS**
- All dimensions shown on the drawings shall be verified by the Contractor and if there are any discrepancies, the contractor shall notify the Architect prior to--proceeding with any work affected by the discrepancy.
  - Unless specified otherwise dimensions shown shall be taken to face of stud, concrete or masonry (whichever is applicable) on all exterior and interior walls
  - Dimensions take precedence over scale.
  - Details marked "tp," Or "typical" shall apply in all cases unless specifically indicated otherwise.
  - Where no specific detail is shown, the framing or construction shall be identical or similar to that indicated for like or similar cases of construction- on this project.
- F. CUTTING AND PATCHING (REMODELING WORK)**
- Match existing materials with new materials so that patching work is undetectable.
  - For cutting work, use proper cutting tools, not chopping tools. Make neat holes. Minimize damage to adjacent work. Check for concealed utilities and structure before cutting.
  - Make patches, seams, and joints durable and inconspicuous. Tolerances for patching shall be the same as for new work.
- G. PROJECT CLOSE-OUT AND FINAL CLEANING**
- At completion of the Work, remove from the job site all tools and equipment, surplus materials, scrap and debris.
  - Inspect exterior and interior surfaces and remove all waste materials, paint droppings, spots, stains or dirt.
  - Schedule final cleaning as approved by the Owner to enable Owner to accept a completely clean project.
  - Final cleaning will be comparable to that provided by professional, skilled cleaners using commercial grade cleaning materials. Cleaning materials will be used with care and will be compatible with building materials and finishes. Final cleaning will include removal of scraps or waste in landscaped areas and thorough cleaning of walkways, desks, paved areas and public paved areas adjacent to the site.

PROJECT DIRECTORY

<b>Owner &amp; Client</b> CITY OF ROSEVILLE PARK DEVELOPMENT ANALYST PARKS, RECREATION & LIBRARIES 316 Vernon Street, Suite 400 Roseville, CA. 95678 (916) 774-5924 Joel De Jong	<b>Architect</b> ATI Architects and Engineers 3009 Douglas Boulevard, #290 Roseville, California 95661 (916) 772-1800 G. Michael Goldsworthy
<b>Structural</b> ZFA Structural Engineers 7801 Folsom Boulevard, Suite 204 Sacramento, CA, 95826 (916) 924-7024 Mark A. Moore	

DRAWING INDEX

<b>GENERAL DRAWING</b>	
G1	TITLE SHEET
<b>ARCHITECTURAL</b>	
A1	SITE PLAN
A2	ROOF PLAN AND DETAILS
<b>STRUCTURAL</b>	
S1	GENERAL NOTES AND TYPICAL DETAILS
S2	ROOF FRAMING PLAN AND DETAILS

PROJECT INFORMATION

<b>BUILDING DATA</b>	
OCCUPANCY	B
BUILDING TYPE	NOT FIRE-SPRINKLED
TOTAL OCCUPANCY LOAD	N/A
BUILDING AREA	2166.6 S.F.
NUMBER OF STORIES	ONE
CONDITIONED	NO
<b>PROJECT SCOPE</b>	
REMOVAL OF OLD LATTICE ROOF AND ADDING NEW ROOFING, GUTTERS AND DOWNSPOUTS ON AN EXISTING GAZEBO AT KASEBERG PARK COMPLEX. THE WHOLE GAZEBO WILL BE REPAINTED.	

SPECIAL INSPECTIONS

SEE STRUCTURAL DRAWINGS FOR MORE INFORMATION.

SYMBOLS

X XX X Y 1 1	DETAIL NUMBER NOTES DETAIL SHEET ELEV LETTER ELEV SHEET KEYNOTE REFERENCE DOOR SCHEDULE REFERENCE KEY
AA X Y △	ELEVATION VIEW ELEVATION LETTER ELEVATION SHEET REVISION NUMBER

APPLICABLE CODES

2016 CALIFORNIA BUILDING CODE WITH CITY OF ROSEVILLE AMENDMENTS 2016 CALIFORNIA MECHANICAL CODE 2016 CALIFORNIA PLUMBING CODE 2016 CALIFORNIA ELECTRICAL CODE WITH CITY OF ROSEVILLE AMENDMENTS 2016 CALIFORNIA FIRE CODE WITH CITY OF ROSEVILLE AMENDMENTS 2016 CALIFORNIA ENERGY CODE (CEC T-24) 2016 CALIFORNIA GREEN BUILDING CODE
ACCESSIBILITY: CITY OF ROSEVILLE BLDG. DIVISION ENFORCES CBC CHAPTERS 11A & 11B.



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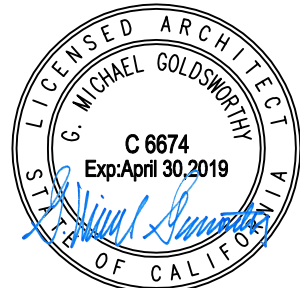
4750 Willow Rd. #250 3009 Douglas Blvd. #290  
Pleasanton, CA 94588 Roseville, CA 95661  
T 925.648.8800 T 916.772.1800

3050 Pullman St.  
Costa Mesa, CA 92626  
T 714.338.1600

ITEM:	REVISIONS	ISSUE:	DATE:
	PERMIT		XX/XX/18

KEY PLAN:

PROFESSIONAL STAMP:



PROJECT TITLE:

**City of Roseville Parks and Recreation Dept.**  
**KASEBERG PARK GAZEBO**  
**ROOFING PROJECT**  
**1151 Rand Way**  
**ROSEVILLE, CA**

SHEET TITLE:

TITLE SHEET


DATE:	SCALE:
07/20/18	AS NOTED
DRAWN/DESIGNED BY:	CHECKED BY:
DAE/	GMG
JOB NO:	
R7806	
CAD FILE:	
+G1-COVR.dwg	

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City of Roseville Approval

SHEET NO:

G1

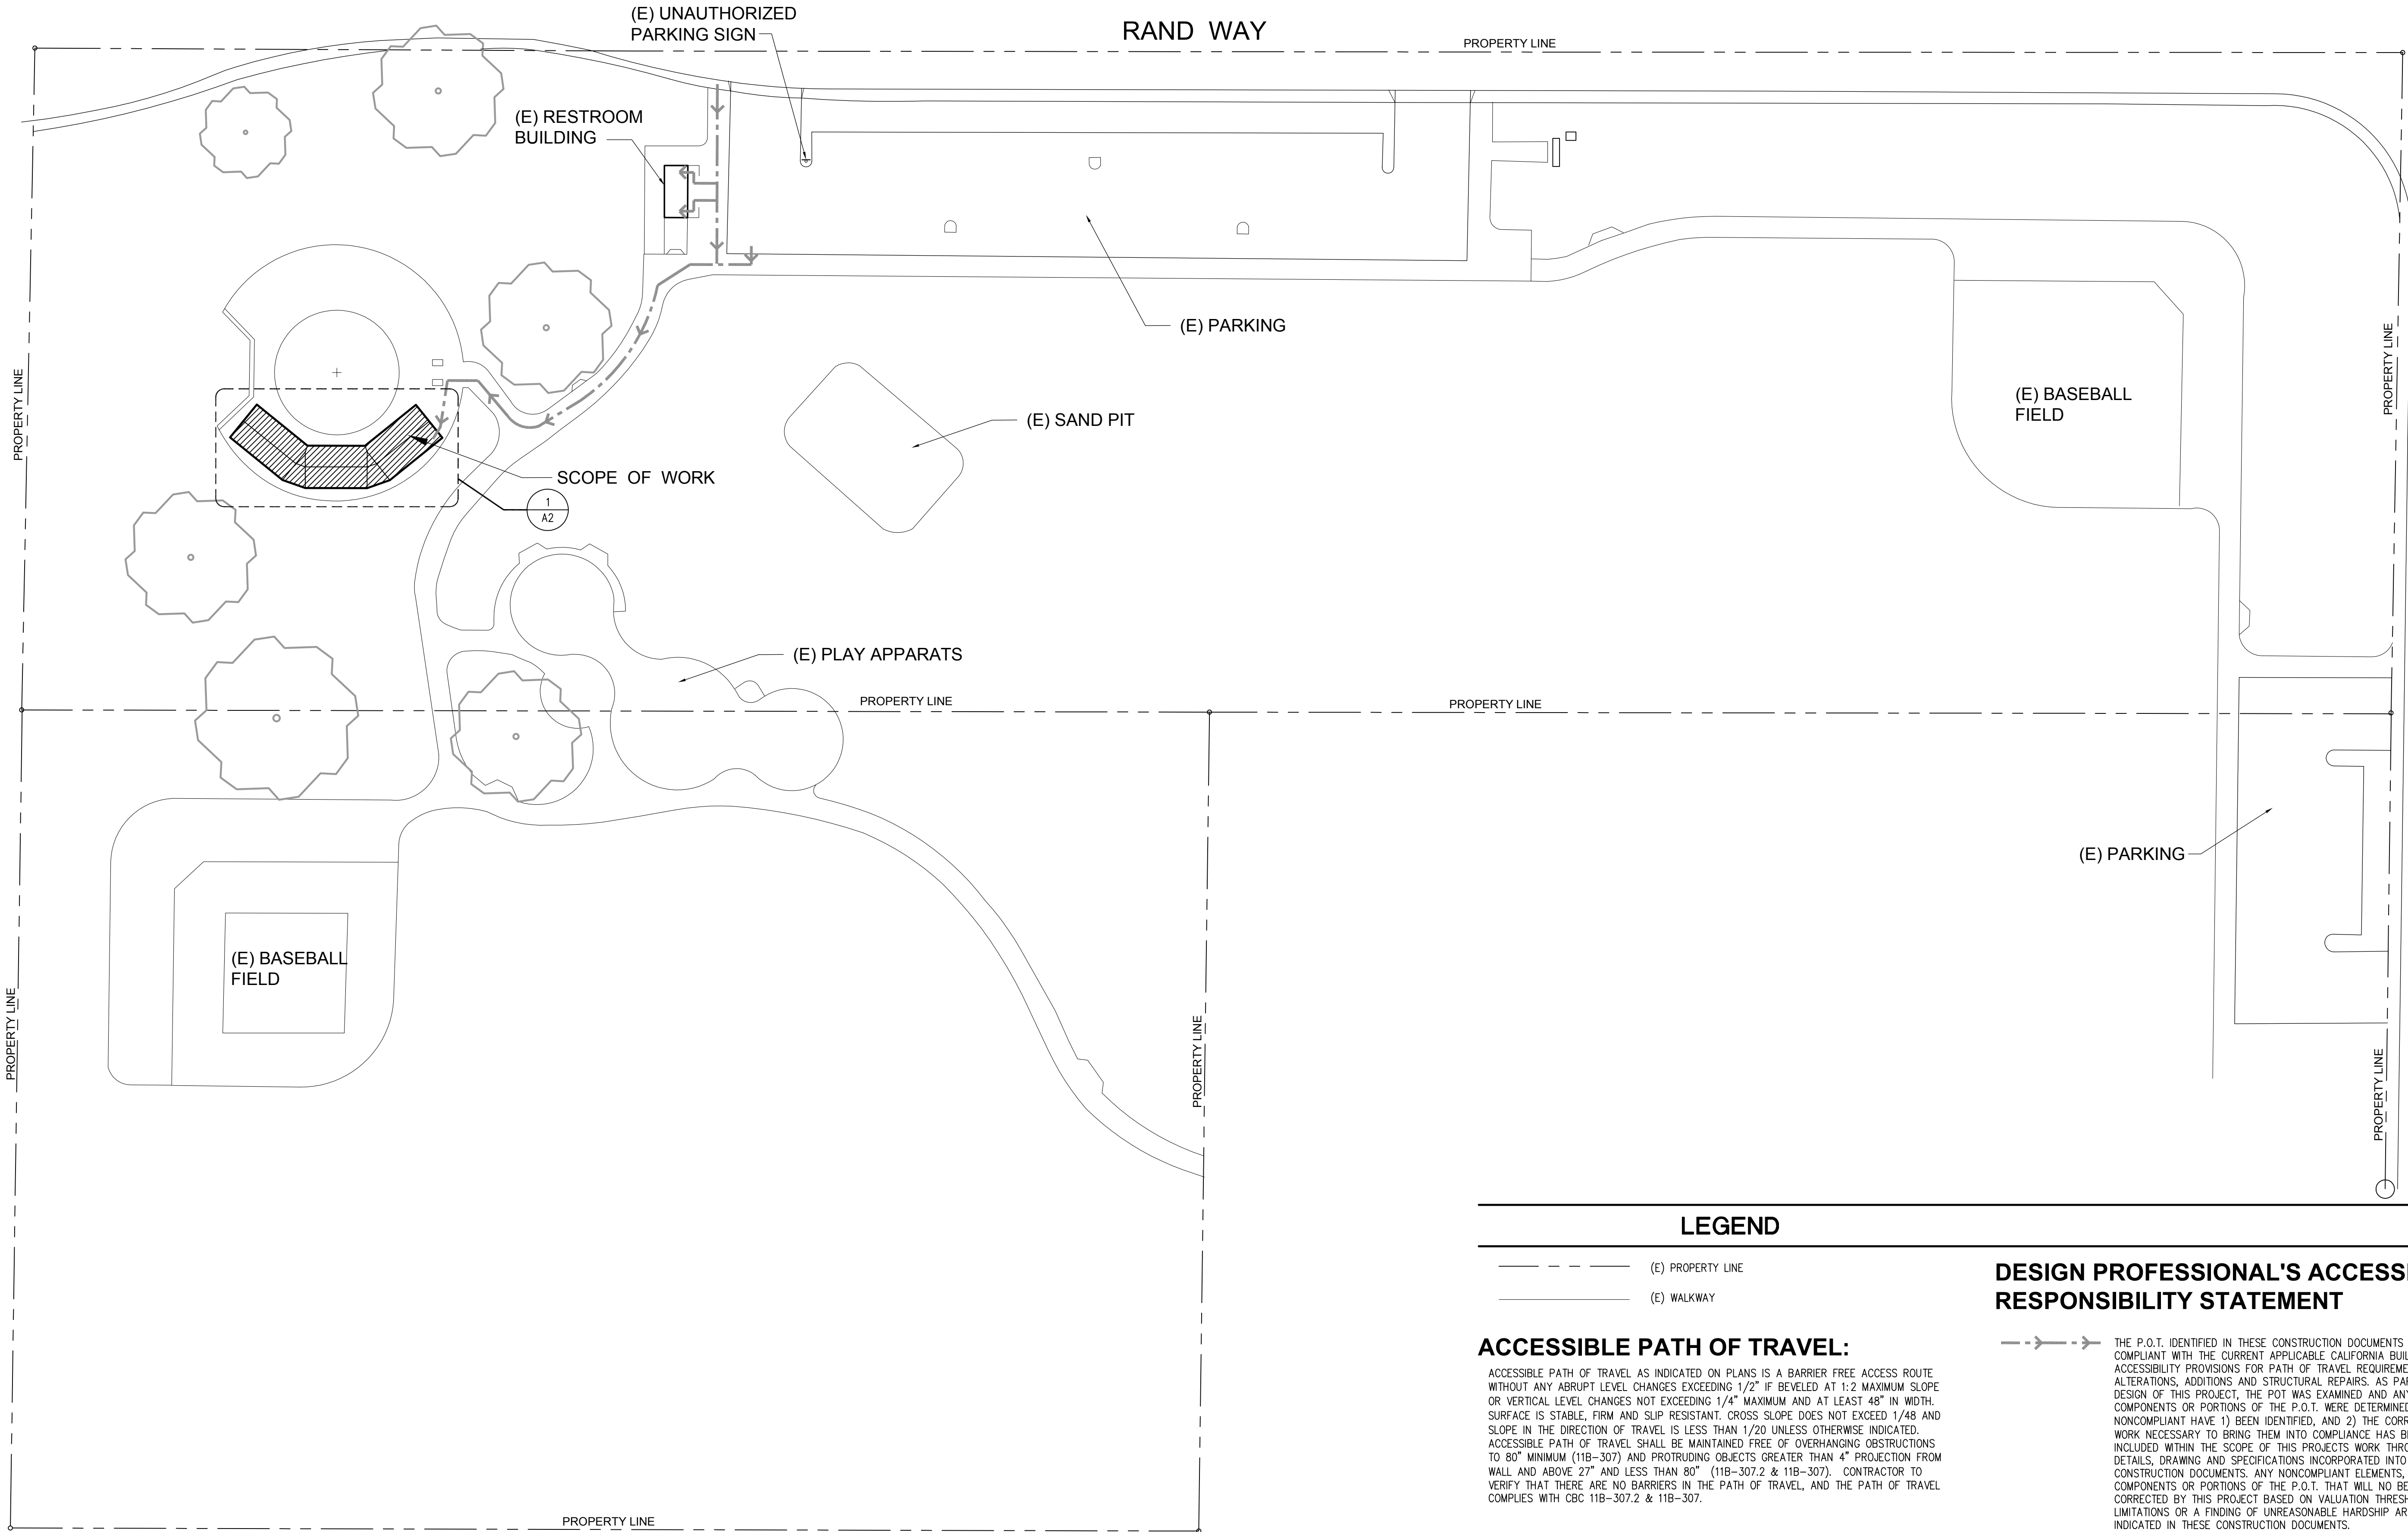

LEGEND

- (E) PROPERTY LINE
- (E) WALKWAY

ACCESSIBLE PATH OF TRAVEL:

ACCESSIBLE PATH OF TRAVEL AS INDICATED ON PLANS IS A BARRIER FREE ACCESS ROUTE WITHOUT ANY ABRUPT LEVEL CHANGES EXCEEDING 1/2" IF BEVELED AT 1:2 MAXIMUM SLOPE OR VERTICAL LEVEL CHANGES NOT EXCEEDING 1/4" MAXIMUM AND AT LEAST 48" IN WIDTH. SURFACE IS STABLE, FIRM AND SLIP RESISTANT. CROSS SLOPE DOES NOT EXCEED 1/48' AND SLOPE IN THE DIRECTION OF TRAVEL IS LESS THAN 1/20 UNLESS OTHERWISE INDICATED. ACCESSIBLE PATH OF TRAVEL SHALL BE MAINTAINED FREE OF OVERHANGING OBSTRUCTIONS TO 80" MINIMUM (11B-307) AND PROTRUDING OBJECTS GREATER THAN 4" PROJECTION FROM WALL AND ABOVE 27" AND LESS THAN 80" (11B-307.2 & 11B-307). CONTRACTOR TO VERIFY THAT THERE ARE NO BARRIERS IN THE PATH OF TRAVEL, AND THE PATH OF TRAVEL COMPLIES WITH CBC 11B-307.2 & 11B-307.

DESIGN PROFESSIONAL'S ACCESSIBLE RESPONSIBILITY STATEMENT

THE P.O.T. IDENTIFIED IN THESE CONSTRUCTION DOCUMENTS IS COMPLIANT WITH THE CURRENT APPLICABLE CALIFORNIA BUILDING CODE ACCESSIBILITY PROVISIONS FOR PATH OF TRAVEL REQUIREMENTS FOR ALTERATIONS, ADDITIONS AND STRUCTURAL REPAIRS. AS PART OF THE DESIGN OF THIS PROJECT, THE POT WAS EXAMINED AND ANY ELEMENTS, COMPONENTS OR PORTIONS OF THE P.O.T. WERE DETERMINED TO BE NONCOMPLIANT HAVE 1) BEEN IDENTIFIED, AND 2) THE CORRECTIVE WORK NECESSARY TO BRING THEM INTO COMPLIANCE HAS BEEN INCLUDED WITHIN THE SCOPE OF THIS PROJECTS WORK THROUGH DETAILS, DRAWING AND SPECIFICATIONS INCORPORATED INTO THESE CONSTRUCTION DOCUMENTS. ANY NONCOMPLIANT ELEMENTS, COMPONENTS OR PORTIONS OF THE P.O.T. THAT WILL NO BE CORRECTED BY THIS PROJECT BASED ON VALUATION THRESHOLD LIMITATIONS OR A FINDING OF UNREASONABLE HARSHIP ARE SO INDICATED IN THESE CONSTRUCTION DOCUMENTS.

IF DURING CONSTRUCTION P.O.T. ITEMS WITHIN THE SCOPE OF THE PROJECT REPRESENTED AS CODE COMPLIANT ARE FOUND TO BE NONCONFORMING BEYOND REASONABLE CONSTRUCTION TOLERANCES, THEY SHALL BE BROUGHT INTO COMPLIANCE WITH CBC AS PART OF THIS PROJECT BY MEANS OF A CONSTRUCTION CHANGE DOCUMENT.

THE SCOPE OF WORK FOR THIS APPLICATION IS UNDER THE CURRENT VALUATION THRESHOLD. THE SCOPE OF ACCESSIBILITY UPGRADES (A.C. PAVING, (E) GATES, SIGNS, & EXISTING NON-COMPLIANT ROUTES AMOUNT TO A MINIMUM OF 20% OF THE TOTAL CONSTRUCTION COST (11B-202.4, EXCEPTION #8).



SCALE : 1"= 40'-0"

1 SITE PLAN



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4750 Willow Rd. #250 3009 Douglas Blvd. #290  
Pleasanton, CA 94588 Roseville, CA 95661  
T 925.648.8800 T 916.772.1800  
3050 Pullman St.  
Costa Mesa, CA 92626  
T 714.338.1600

ITEM:	REVISIONS/ISSUE:	DATE:
	PERMINT	08/17/18

KEY PLAN:

PROFESSIONAL STAMP:



PROJECT TITLE:

City of Roseville Parks  
and Recreation Dept.  
**KASEBERG PARK  
GAZEBO  
ROOFING PROJECT  
1151 Rand Way  
ROSEVILLE, CA**

SHEET TITLE:


SITE PLAN

DATE:	SCALE:
08/17/18	AS NOTED
DRAWN/DESIGNED BY:	CHECKED BY:
DAE/	GMG
JOB NO:	
R7806	
CAD FILE:	
+A1_Site.dwg	


SHEET NO:

City of Roseville Approval

A1

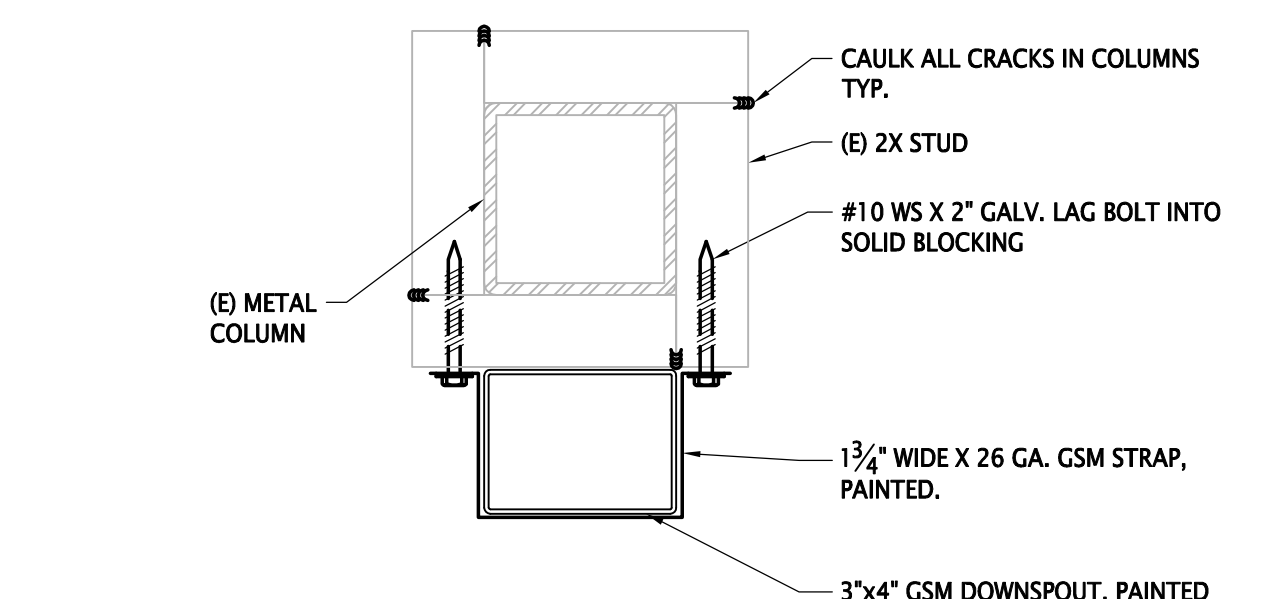


7 DOWNSPOUT CONNECTION AT COLUMN SCALE: 3"=1'-0"

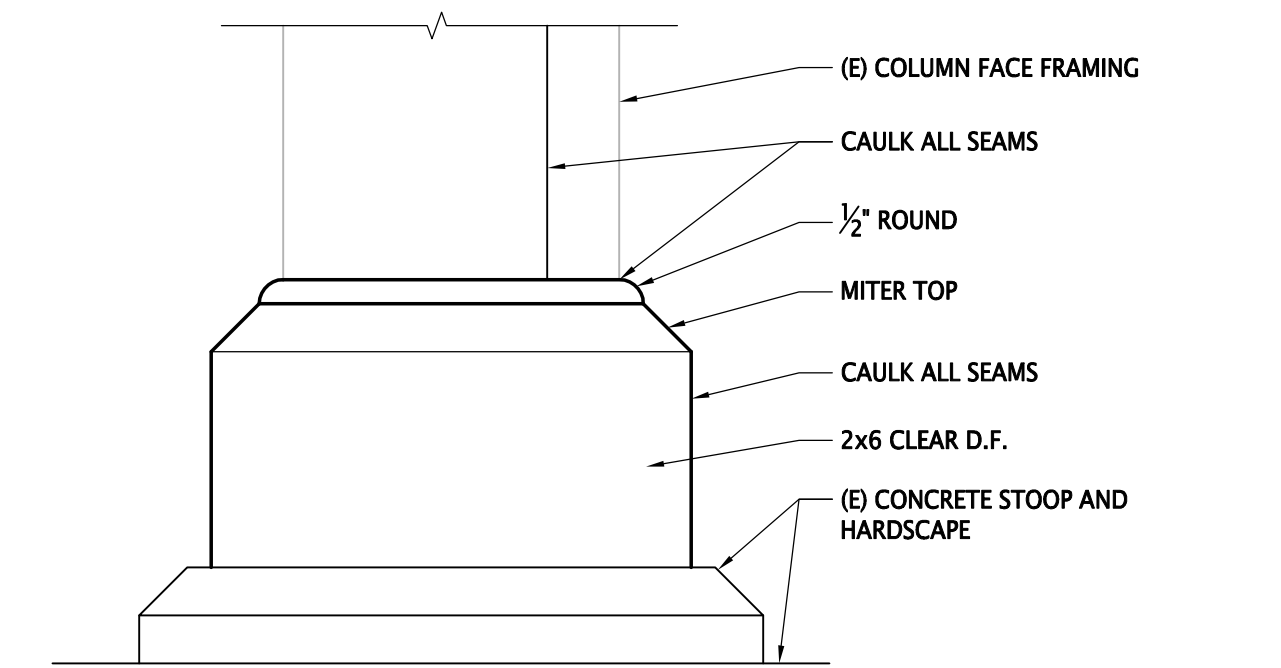


8 COLUMN BASE SCALE: 3"=1'-0"


NOTE: SIGNAGE MUST BE FIELD INSPECTED PER 2016 CBC 11B-703.1 INCLUDING 703.1.1, 703.1.1.1, 703.1.1.2

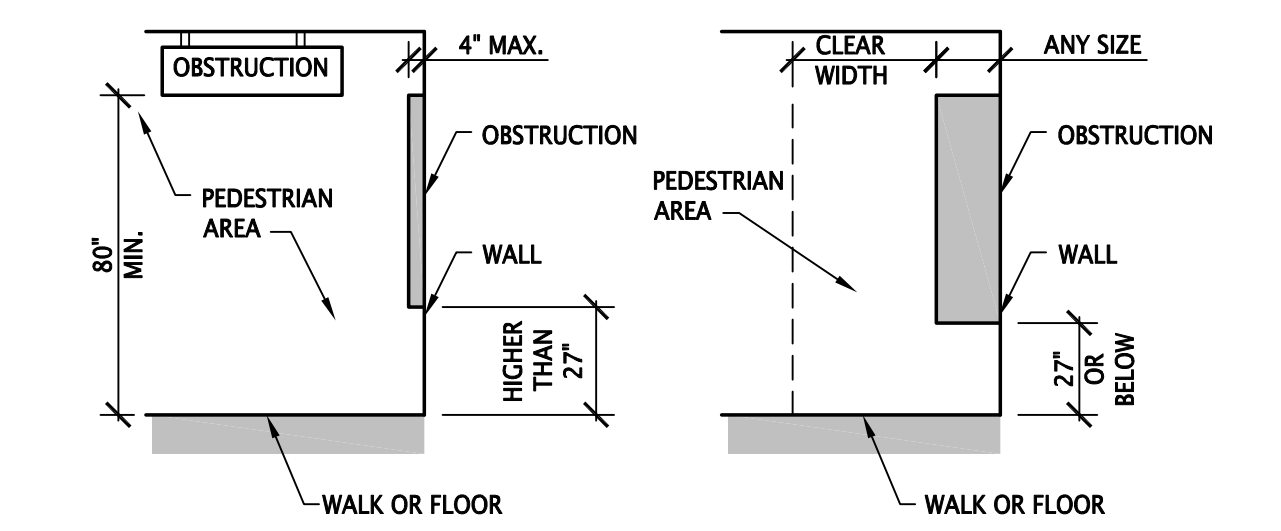


9 PATH OF TRAVEL CLEARANCES SCALE: 1/4"=1'-0"

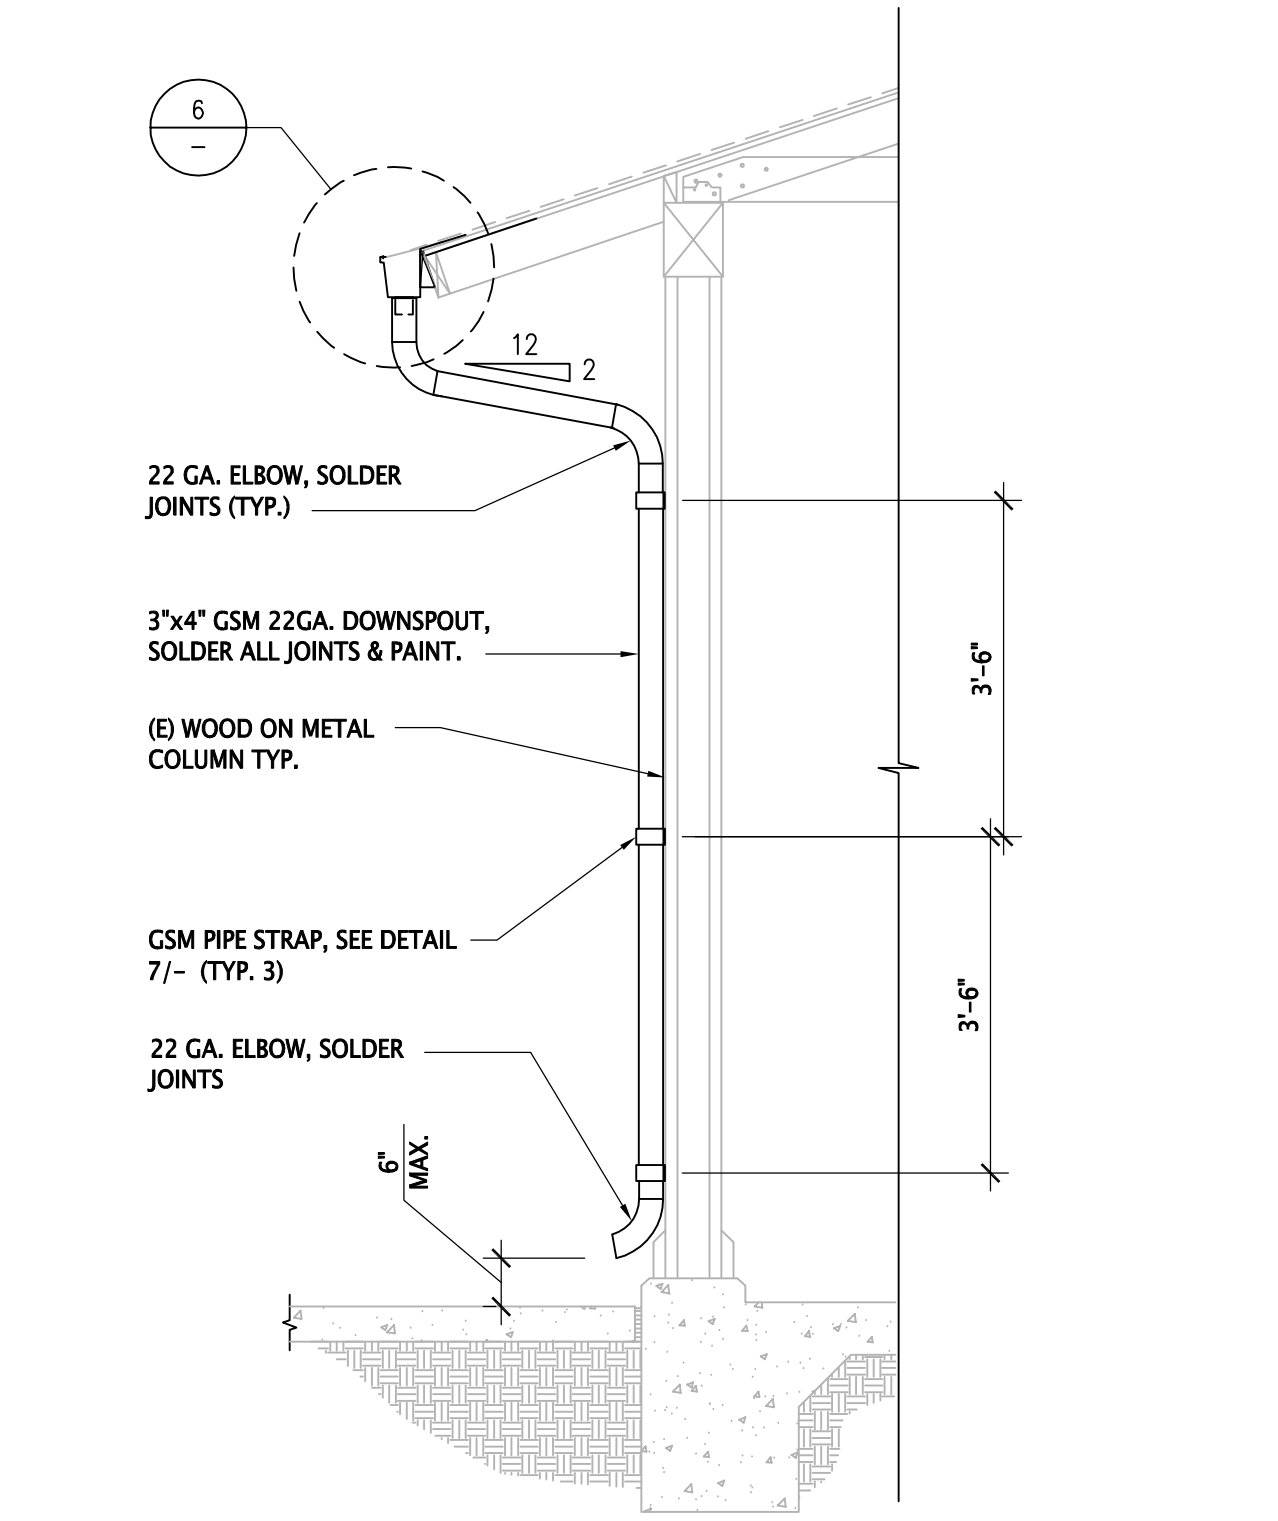


5 DOWNSPOUT AT COLUMN SCALE: 1/2"=1'-0"

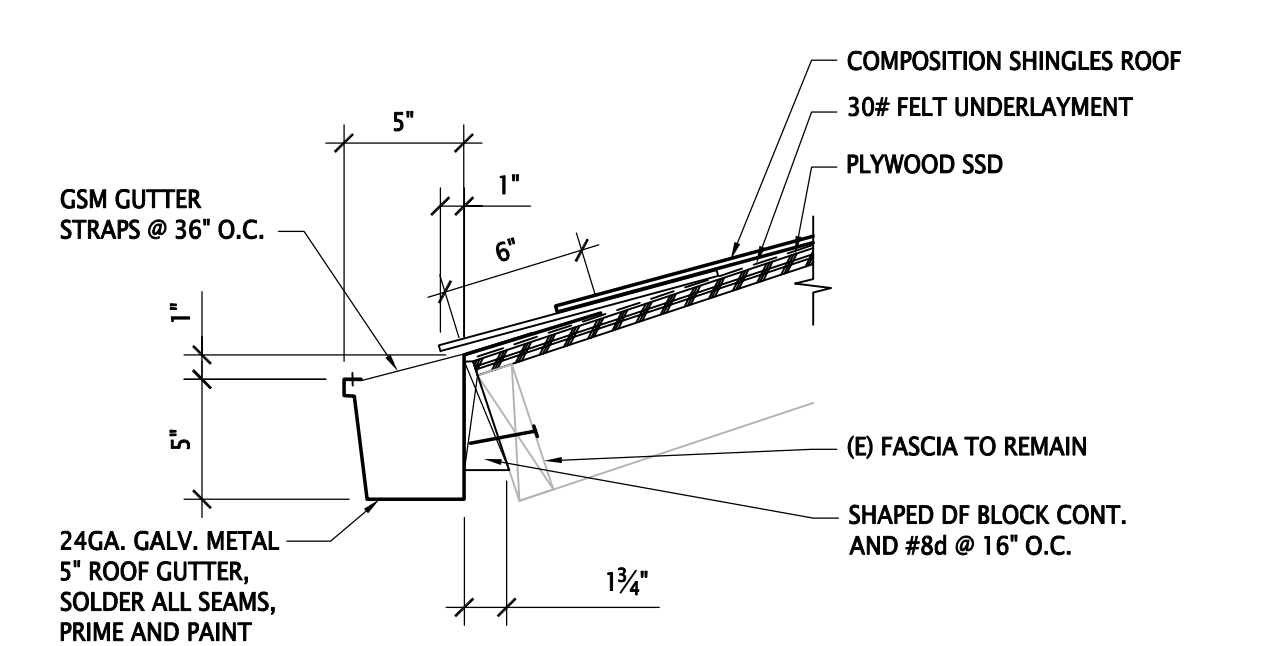


6 GUTTER SCALE: 1 1/2"=1'-0"

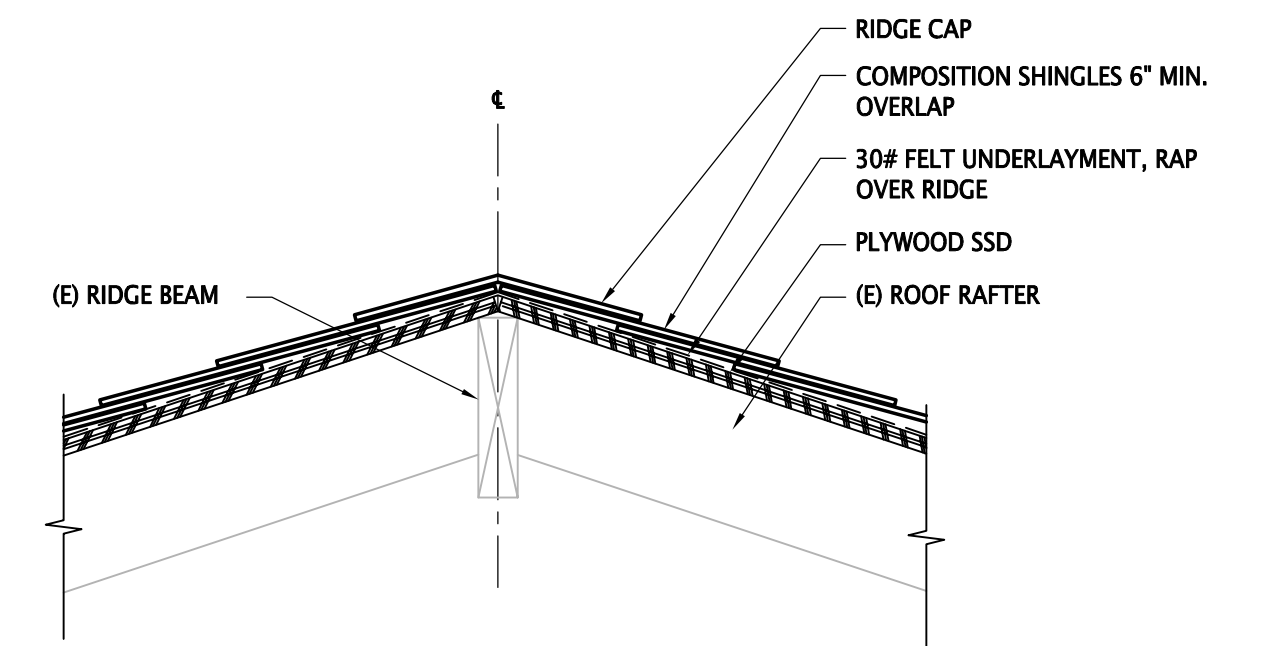


2 RIDGE / HIP SCALE: 1 1/2"=1'-0"

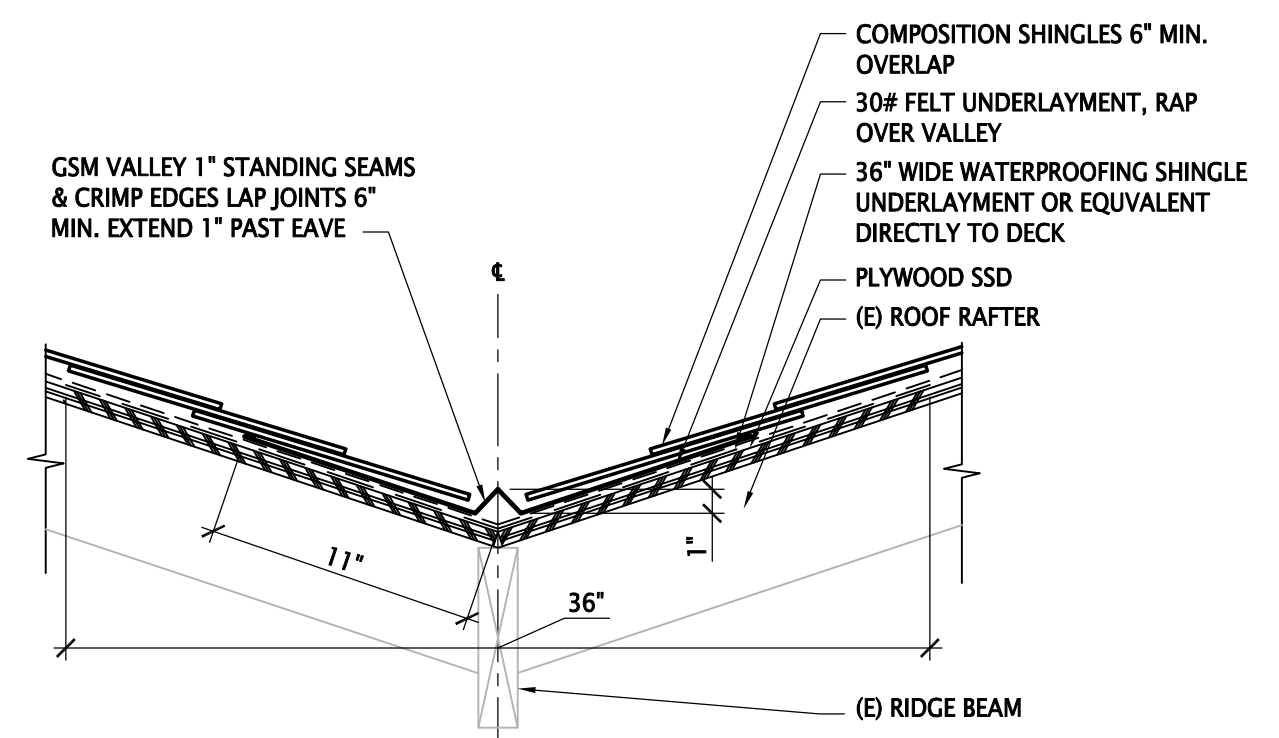

3 VALLEY SCALE: 1 1/2"=1'-0"

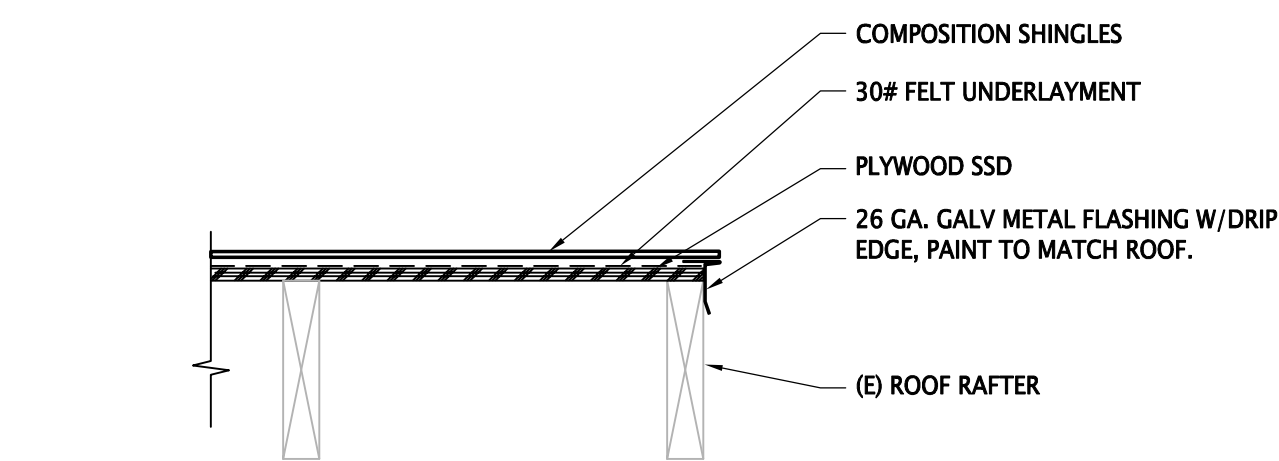

4 RAKE TRIM SCALE: 1 1/2"=1'-0"

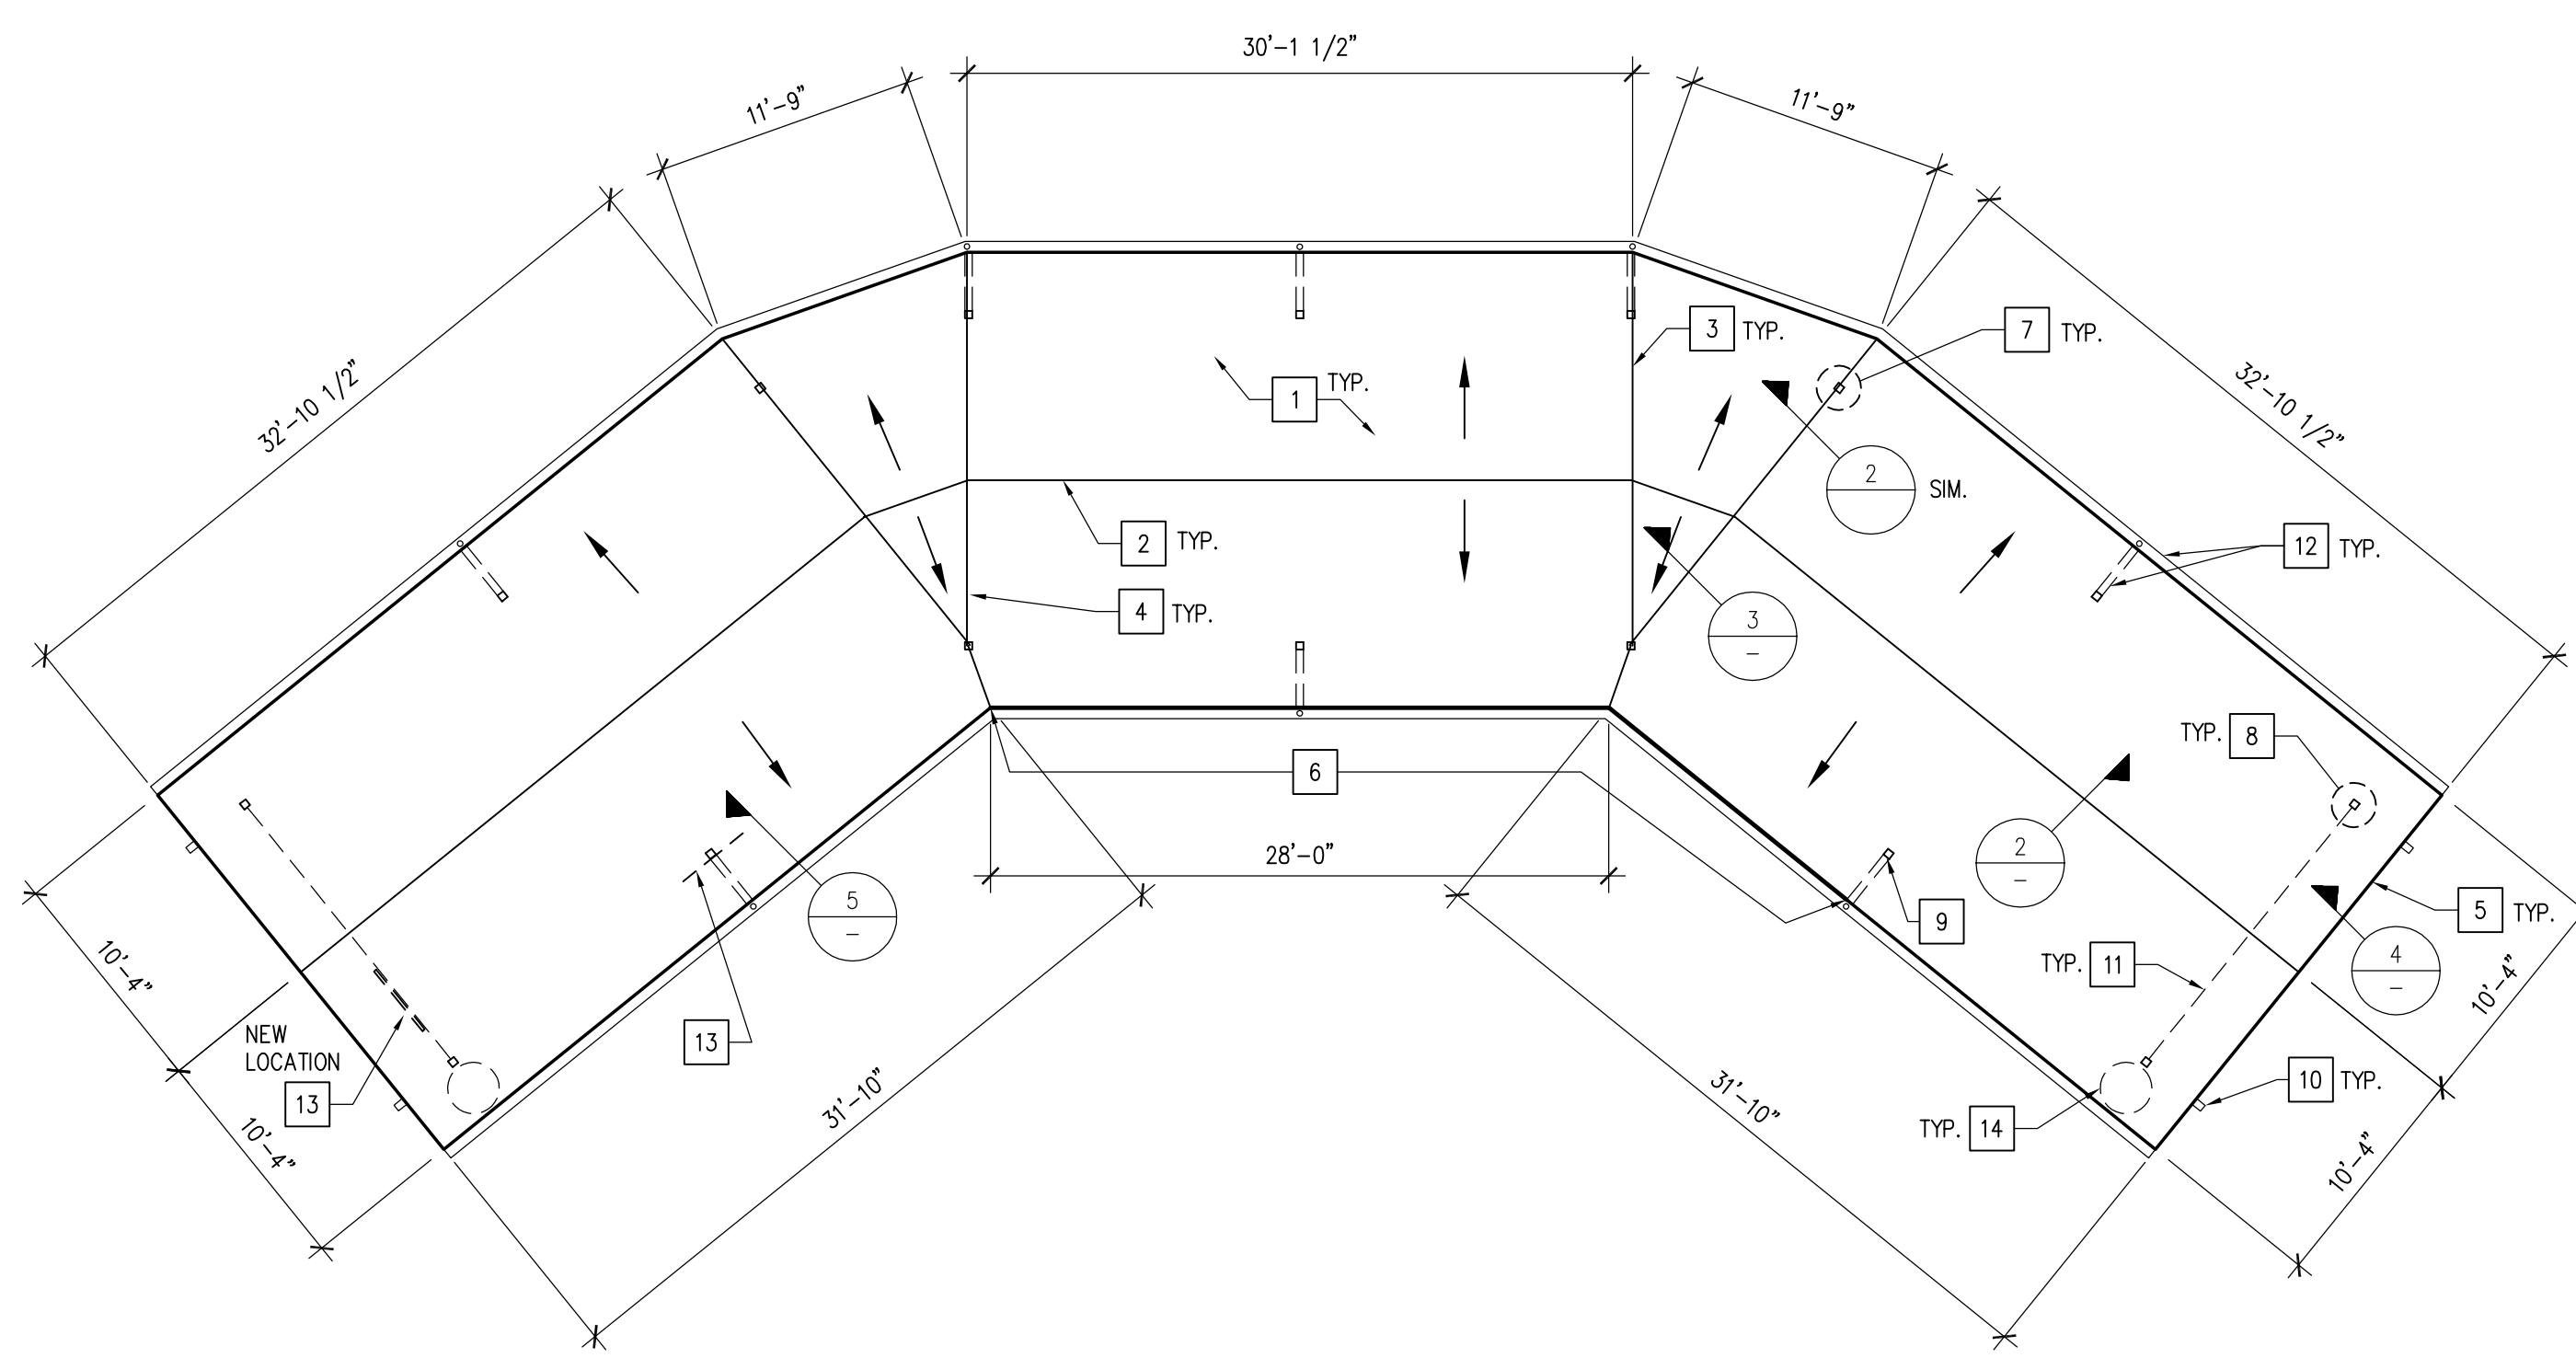

1 ROOF PLAN SCALE: 1/8"=1'-0"


KEYNOTES

- 1. COMPOSITION SHINGLE ROOF OVER FELT UNDERLAYMENT OVER PLYWOOD.
- 2. TYP. RIDGE
- 3. TYP. HIP
- 4. TYP. VALLEY
- 5. TYP. RAKE
- 6. REMOVE AND REPLACE 2x6 FASCIA WHERE NOTED ON PLAN. MOUNT WITH SCREWS AND MITER ENDS TO MATCH (E) CONDITIONS.
- 7. REPLACE ALL (E) WOOD COLUMN BASES PER DETAIL 8/- CAULK ALL WOOD COLUMN FACES SEE DETAIL 7/- COLUMNS SHOWN FOR REFERENCE ONLY.
- 8. CAULK ALL COLUMN CAPITALS
- 9. REPLACE ENTIRE 2x COLUMN FACE TO MATCH (E) CONDITION WHERE GOUGING AND HOLES HAVE HAPPENED. CAULK ALL COLUMN FACES.
- 10. SEE STRUCTURAL DRAWINGS FOR CUTTING BACK OF DRY ROOT OF WORST BEAM END. CUT BACK ALL OTHER BEAMS ENDS TO MATCH NEW LENGTH OF BEAM, MITER ALL ENDS OF BEAMS TO MATCH (E) CONDITIONS.
- 11. REMOVE LATCH WOOD AT ENDS OF BOTH GABLE ENDS. DO NOT REPLACE PREP AREA FOR NEW PAINT.
- 12. GUTTER AND DOWNSPOUT SEE DETAIL 5/-
- 13. REMOVE SIGN AND MOVE TO GABLE END. MOUNT SIGN TO HAVE 80" CLEAR. SEE DETAIL 9/-
- 14. (E) TRASH BEN TO REMAIN



ITEM	REVISIONS	ISSUE	DATE
	PERMIT		08/17/18

KEY PLAN:

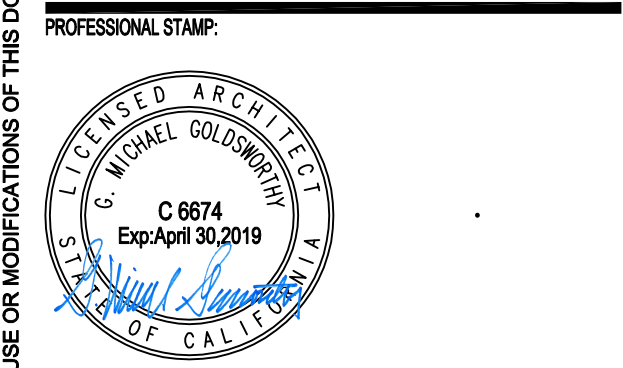

PROJECT TITLE: City of Roseville Parks and Recreation Dept. KASEBERG PARK GAZEBO ROOFING PROJECT 1151 Rand Way ROSEVILLE, CA

ROOF PLAN AND DETAILS

GENERAL NOTES

- 1. DEMOLITION: REMOVE EXISTING OPEN LATTICE ROOFING. NOTIFY ARCHITECT OF ANY DAMAGED AREAS OR ROTTED AREAS. PAINT (N) FASTENERS & FLASHING WHERE EXPOSED TO MATCH (E) ADJACENT COLOR.
- 2. NEW ROOF SYSTEM: INSTALL PLYWOOD SHEETING PER STRUTURAL DRAWINGS. INSTALL COMPOSITE ROOF SHINGLE SYSTEM WITH DRIP FLASHING, SEE SPECIFICATIONS. NEW ROOF SYSTEM TO SLOPE AS EXISTING.
- 3. PRIME AND PAINT (N) EXPOSED AND VISIBLE SHEET METAL AND PLYWOOD SHEETING AND ANY DRY ROT REPLACEMENT WOOD. FINISH PAINT ENTERER STRUCTURE.
- 4. DIMENSIONS ARE APPROXIMATE AND ARE SHOWN ON THE PLANS FOR RE-ROOFING ONLY, TO AID CONTRACTOR IN MATERIAL TAKE-OFFS. ACTUAL LENGTH MAY VARY. V.I.F.

DATE	SCALE
08/17/18	AS NOTED
DRAWN/DESIGNED BY:	CHECKED BY:
DAE/	GMG
JOB NO:	
R7806	
CAD FILE:	
+A2_Rof.dwg	

For Council approval Do Not use for bidding A2

### WOOD CONSTRUCTION (CARPENTRY)

- | SAWN LUMBER MEMBER    | SPECIES AND MINIMUM GRADE - UNO | F <sub>b</sub> (PSI) | F <sub>v</sub> (PSI) | E (PSI)             |
|-----------------------|---------------------------------|----------------------|----------------------|---------------------|
| 6x POSTS              | DOUGLAS FIR - #1                | 1200                 | 170                  | 1.6x10 <sup>6</sup> |
| 6x BEAMS              | DOUGLAS FIR - #1                | 1350                 | 170                  | 1.6x10 <sup>6</sup> |
| 4x POSTS & BEAMS      | DOUGLAS FIR - #1                | 1000                 | 180                  | 1.7x10 <sup>6</sup> |
| 2x JOISTS, RAFTERS    | DOUGLAS FIR - #2                | 900                  | 180                  | 1.6x10 <sup>6</sup> |
| RP MATERIAL           | DOUGLAS FIR - #2                | 900                  | 180                  | 1.6x10 <sup>6</sup> |
| 2x STUDS > 10' HEIGHT | DOUGLAS FIR - #2                | 900                  | 180                  | 1.6x10 <sup>6</sup> |

- | WIRE NAIL  | MINIMUM SHANK DIAMETER | MINIMUM NAIL LENGTH UNO | TYPICAL NAIL APPLICATION, UNO |
|------------|------------------------|-------------------------|-------------------------------|
| 16d COMMON | 0.162"                 | 3½"                     | FRAMING                       |
| 16d SINKER | 0.148"                 | 3½"                     | FRAMING                       |
| 10d COMMON | 0.148"                 | 3"                      | FRAMING                       |
| 10d COMMON | 0.148"                 | PER 2/S1                | SHEATHING                     |
| 8d COMMON  | 0.131"                 | PER 2/S1                | SHEATHING                     |

8. WOOD ADHESIVE SHALL BE WATER-PROOF, CARTRIDGE DISPENSED, MEETING APA PRODUCT SPECIFICATION AFG-01 OR ASTM D3498. LOCTITE "PL PREMIUM" OR EQUAL, FOR USE AT SUBFLOOR SHEATHING AND WHERE SPECIFICALLY NOTED FOR USE ON DRAWINGS.

1. STRUCTURAL SHEATHING SHALL CONFORM TO PRODUCT STANDARD PS-1 OR PS-2

- ALL PANELS SHALL HAVE AN EXTERIOR EXPOSURE RATING AND BEAR THE TRADEMARK OF THE ENGINEERED WOOD ASSOCIATION (APA) OR OTHER QUALIFIED AGENCY. SHEATHING SHEETS SHALL BE SPLICED ALONG CENTERLINE OF FRAMING MEMBER WITH NAILING SPACING NOT LESS THAN  $\frac{3}{4}$ " FROM EDGE OF SHEETS. MACHINE-PLACED NAILING AND NAILS TO BE APPROVED BY THE ENGINEER PRIOR TO USE. SHEATHING NAILS OF COMMON WIRE WITH FULL ROUND HEADS ARE REQUIRED.
2. OSB WITH EQUIVALENT THICKNESS AND SPAN RATING MAY BE USED IN LIEU OF PLYWOOD CALLED OUT. ALL OSB SHALL CONFORM TO PS-2.

## DESIGN CRITERIA

**EARTHQUAKE DATA:**  
 SEISMIC IMPORTANCE FACTOR,  $I_e$ : 1.0  
 MAPPED SPECTRAL RESPONSE ACCELERATIONS:  $S_{B1} = 0.51$ ;  $S_{B2} = 0.25$   
 SITE CLASS: D  
 SPECTRAL RESPONSE COEFFICIENTS:  $S_{DS} = 0.475$ ;  $S_{D1} = 0.319$   
 SEISMIC DESIGN CATEGORY: D  
 SEISMIC FORCE RESISTING SYSTEM(S): CANTILEVERED COLUMN  
 SYSTEM  
 RESPONSE MODIFICATION FACTOR(S):  $R = 1.25$   
 DESIGN BASE SHEAR: 8.6k  
 SEISMIC RESPONSE COEFFICIENT(S):  $C_u = 0.38$   
 ANALYSIS PROCEDURE USED: EQUIVALENT LATERAL FORCE

1. REFER TO SHEETS **S1** FOR STANDARD DETAILS OF CONSTRUCTION. REFER TO THE PROJECT SPECIFICATIONS FOR MATERIALS AND METHODS.

2. BUILDING DIMENSIONS SHOWN ARE FOR GENERAL REFERENCE ONLY AND SHOULD BE VERIFIED IN FIELD. ANY DISCREPANCIES ARE TO BE BROUGHT TO THE ATTENTION OF THE ENGINEER SO CLARIFICATION CAN BE MADE PRIOR TO COMMENCING WORK.
3. STRUCTURAL DRAWINGS SHALL NOT BE SCALED. ALL DIMENSIONS AND FIT SHALL BE DETERMINED AND VERIFIED BY THE CONTRACTOR PRIOR TO COMMENCING WORK.
4. DETAILS NOT FULLY OR SPECIFICALLY SHOWN SHALL BE OF SAME NATURE AS OTHER SIMILAR CONDITIONS.
5. SHORING AND BRACING DESIGN, MATERIALS AND INSTALLATION SHALL BE PROVIDED BY THE GENERAL CONTRACTOR, AND SHALL BE ADEQUATE FOR ALL LOADS. LEAVE IN PLACE AS LONG AS MAY BE REQUIRED FOR SAFETY AND UNTIL FINAL STRUCTURAL CONSTRUCTION IS COMPLETED.

1. IN PREPARING THE PROJECT PLANS, THE SOURCE OF INFORMATION WAS BASED ON THE EXISTING BUILDING PLANS PREPARED BY ROYSTON HANAMOTO ALLEY & ABEY, DATED JANUARY 1990. THE CONTRACTOR SHALL VERIFY ALL EXISTING JOB CONDITIONS, REVIEW THE PLANS AND VERIFY ALL DIMENSIONS PRIOR TO CONSTRUCTION. THE CONTRACTOR SHALL NOTIFY THE ARCHITECT/ENGINEER OF ALL DISCREPANCIES AND EXCEPTIONS BEFORE PROCEEDING WITH ANY WORK. DRAWINGS FOR THE EXISTING CONSTRUCTION ARE AVAILABLE FOR REVIEW.


2. ALL WORK NOT INDICATED AS EXISTING (E) SHALL BE ASSUMED TO BE NEW (N).
3. ANY REMOVAL, CUTTING, DRILLING, ETC OF EXISTING WORK SHALL BE PERFORMED WITH GREAT CARE. SMALL TOOLS SHALL BE USED IN ORDER NOT TO JEOPARDIZE THE STRUCTURAL INTEGRITY OF THE STRUCTURE IF STRUCTURAL MEMBERS OR MECHANICAL, ELECTRICAL, OR ARCHITECTURAL ELEMENTS NOT INDICATED FOR REMOVAL INTERFERE WITH THE NEW WORK. THE ARCHITECT/ENGINEER SHALL BE IMMEDIATELY NOTIFIED AND PRIOR APPROVAL SHALL BE OBTAINED BEFORE REMOVAL OF THE MEMBERS.
4. DO NOT OVER CUT EXISTING WOOD TO REMAIN. CUTS SHALL BE MADE NEATLY TO A CORNER, THEN ALTERNATE MEANS SHALL BE USED TO REMOVE REMAINING MATERIAL. CONTRACTOR IS RESPONSIBLE FOR REPAIR/REPLACEMENT OF OVER CUT MATERIAL AS DIRECTED BY THE ARCHITECT AND/OR ENGINEER.
5. EXISTING DAMAGED STRUCTURAL MEMBERS WHICH ARE UNCOVERED SHALL BE REPORTED TO THE ARCHITECT/ENGINEER FOR REVIEW AND REPAIR.
6. REMODELING REQUIRES ASSUMPTIONS BE MADE REGARDING EXISTING CONDITIONS WHICH MAY NOT BE VERIFIABLE WITHOUT DESTROYING OTHERWISE ADEQUATE OR SERVICEABLE PORTIONS OF THE STRUCTURE. THIS ANALYSIS DOES NOT MAKE ANY GUARANTEE TO THE ADEQUACY OF THE STRUCTURAL DESIGN OF THE EXISTING BUILDING NOT SPECIFICALLY ADDRESSED IN THE STRUCTURAL CALCULATIONS. ZFA SHALL NOT BE RESPONSIBLE FOR UNSATISFACTORY PERFORMANCE OF EXISTING PORTIONS OF THE STRUCTURE NOT SPECIFICALLY ADDRESSED IN THE CONSTRUCTION DOCUMENTS.

1. SEE 2/S1 FOR SHEATHING NAILING REQUIREMENTS. ALL NAILING NOT NOTED OR DETAILED OTHERWISE SHALL BE PER 1/S1 . NAIL LENGTH TO BE SUFFICIENT TO MEET CBC PENETRATION REQUIREMENTS.

2. FOR ROOF DRAINAGE, TOP OF FRAMING BETWEEN NOTED POINTS IS A STRAIGHT LINE.
3. THE CONTRACTOR SHALL VERIFY THAT THE MOISTURE CONTENT OF ALL FRAMING LUMBER AND SHEATHING MEET THE REQUIREMENTS OF THE SPECIFICATIONS AT THE TIME OF INSTALLATION AND AT CLOSE-IN.
4. ALL SHEATHING SHALL HAVE 1/8" GAP AT ALL EDGES AND JOINTS. TYPICAL SHEATHING:
  - A. SLOPING ROOF SHEATHING (SLOPE GREATER THAN 2:12): 1/2" APA RATED SHEATHING (32'16" EXP 1 WITH 104 @ 6" OC EDGES (PEN) AND 12" OC FIELD ONLY). LAY PERPENDICULAR TO FRAMING MEMBERS. PROVIDE SHIMS CLIPS AT UNSUPPORTED EDGES UNLESS NOTED TO BE BLOCKED ON PLANS. NO PANELS LESS THAN 24" WIDE SHALL BE USED. STAGGER SHEETS.

1. ALL SOFT AND DISCOLORED MATERIAL SHALL BE REMOVED UNTIL EXPOSED WOOD IS NATURAL COLORED. ONCE THE NATURAL COLOR IS EXPOSED IT SHOULD BE TREATED WITH AWWA USE CATEGORY UC3B WOOD PRESERVATIVE.
2. WHERE MORE THAN 5% OF THE CROSS-SECTIONAL AREA IS REMOVED FROM ANY MEMBER, REPLACE MEMBER IN LIKE KIND.
3. CONTACT SEOR FOR FIELD OBSERVATION AND GUIDANCE TO SALVAGE SEVERE ROT CONDITIONS. OTHERWISE REPLACE IN LIKE KIND.

# 1 NAILING SCHEDULE

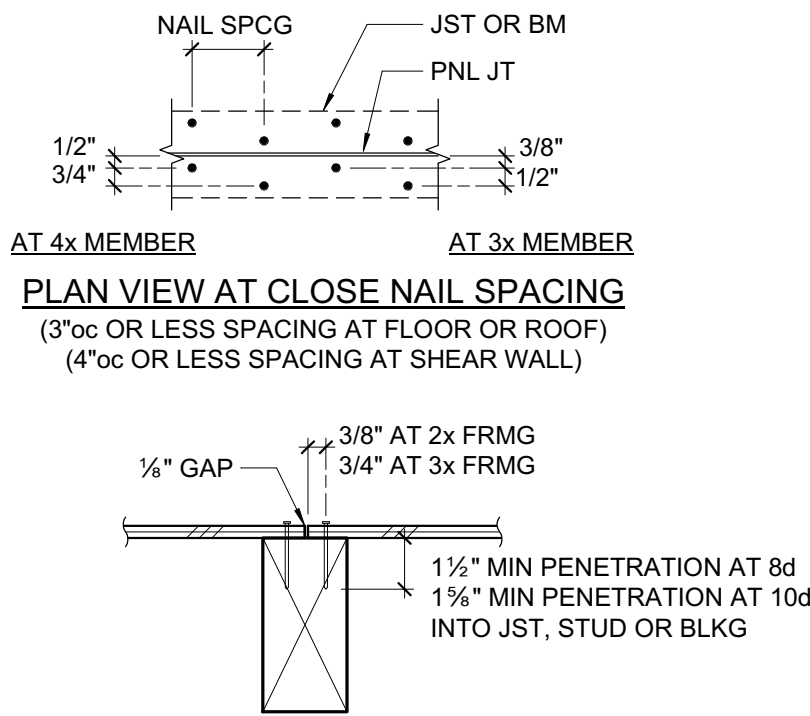

SECTION AT TYP NAIL SPACING


**NOTE:**  
SHEATHING SHEETS ARE TO BE AS LARGE AS POSSIBLE. STAGGER SHEETS. JOINTS ARE TO BE CENTERED OVER BEARING. NAIL HEADS SHALL BE DRIVEN FLUSH W/ SHEATHING. MINIMUM SHEATHING SIZE IS 24" WIDTH x 48" LENGTH AT FLOOR AND ROOF, AND 12"x48" AT WALLS.

$$1\frac{1}{2}'' = 1'-0''$$
[illegible]

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OTHER PROJECT WITHOUT THE PRIOR WRITTEN  
AUTHORIZATION OF THE ENGINEER.

Revision Schedule		
#	Revision Description	Date

**ZFA STRUCTURAL ENGINEERS**  
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sacramento ca 95826  
zfa job no. 18186.01  
zfa.com  
916.924.7024  
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PROJECT

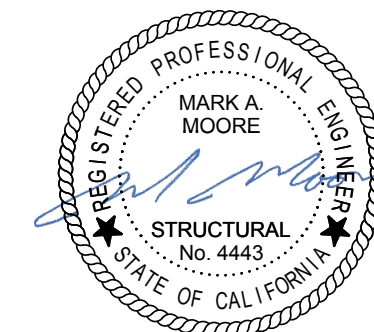**KASEBURG GAZEBO  
RETROFIT**

KASEBURG PARK  
1151 RAND WAY  
ROSEVILLE, CA 95678

SHEET DESCRIPTION


## ROOF FRAMING PLAN AND DETAILS

ENGR:	DATE: 6/26/2018
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PM: MCK

SHEET


# USE S2

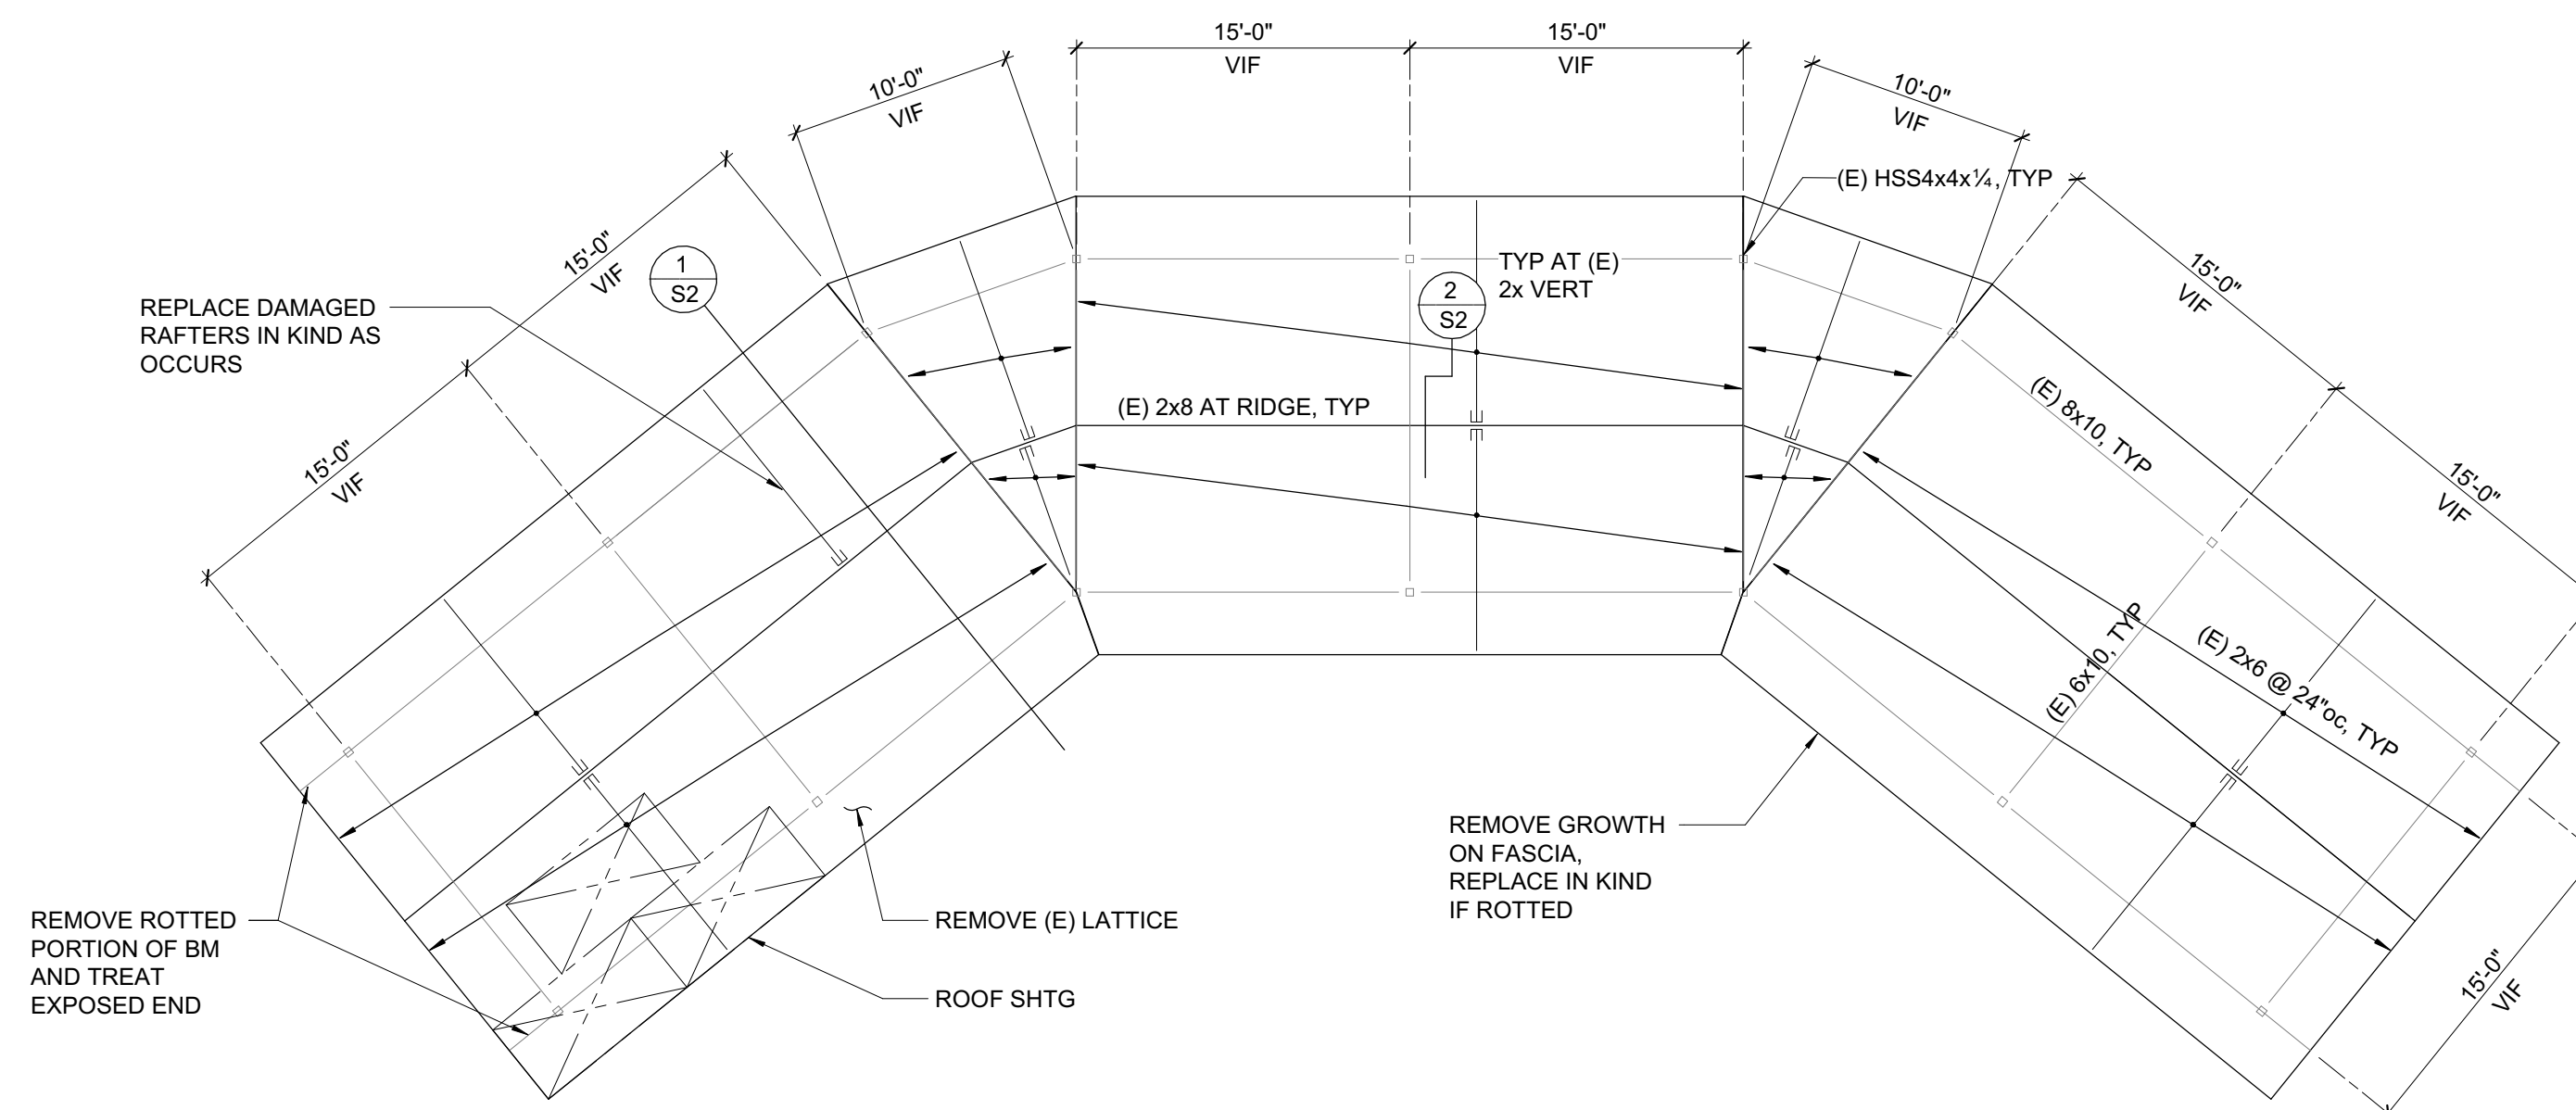


## ROOF FRAMING PLAN

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1/8" = 1'-0"

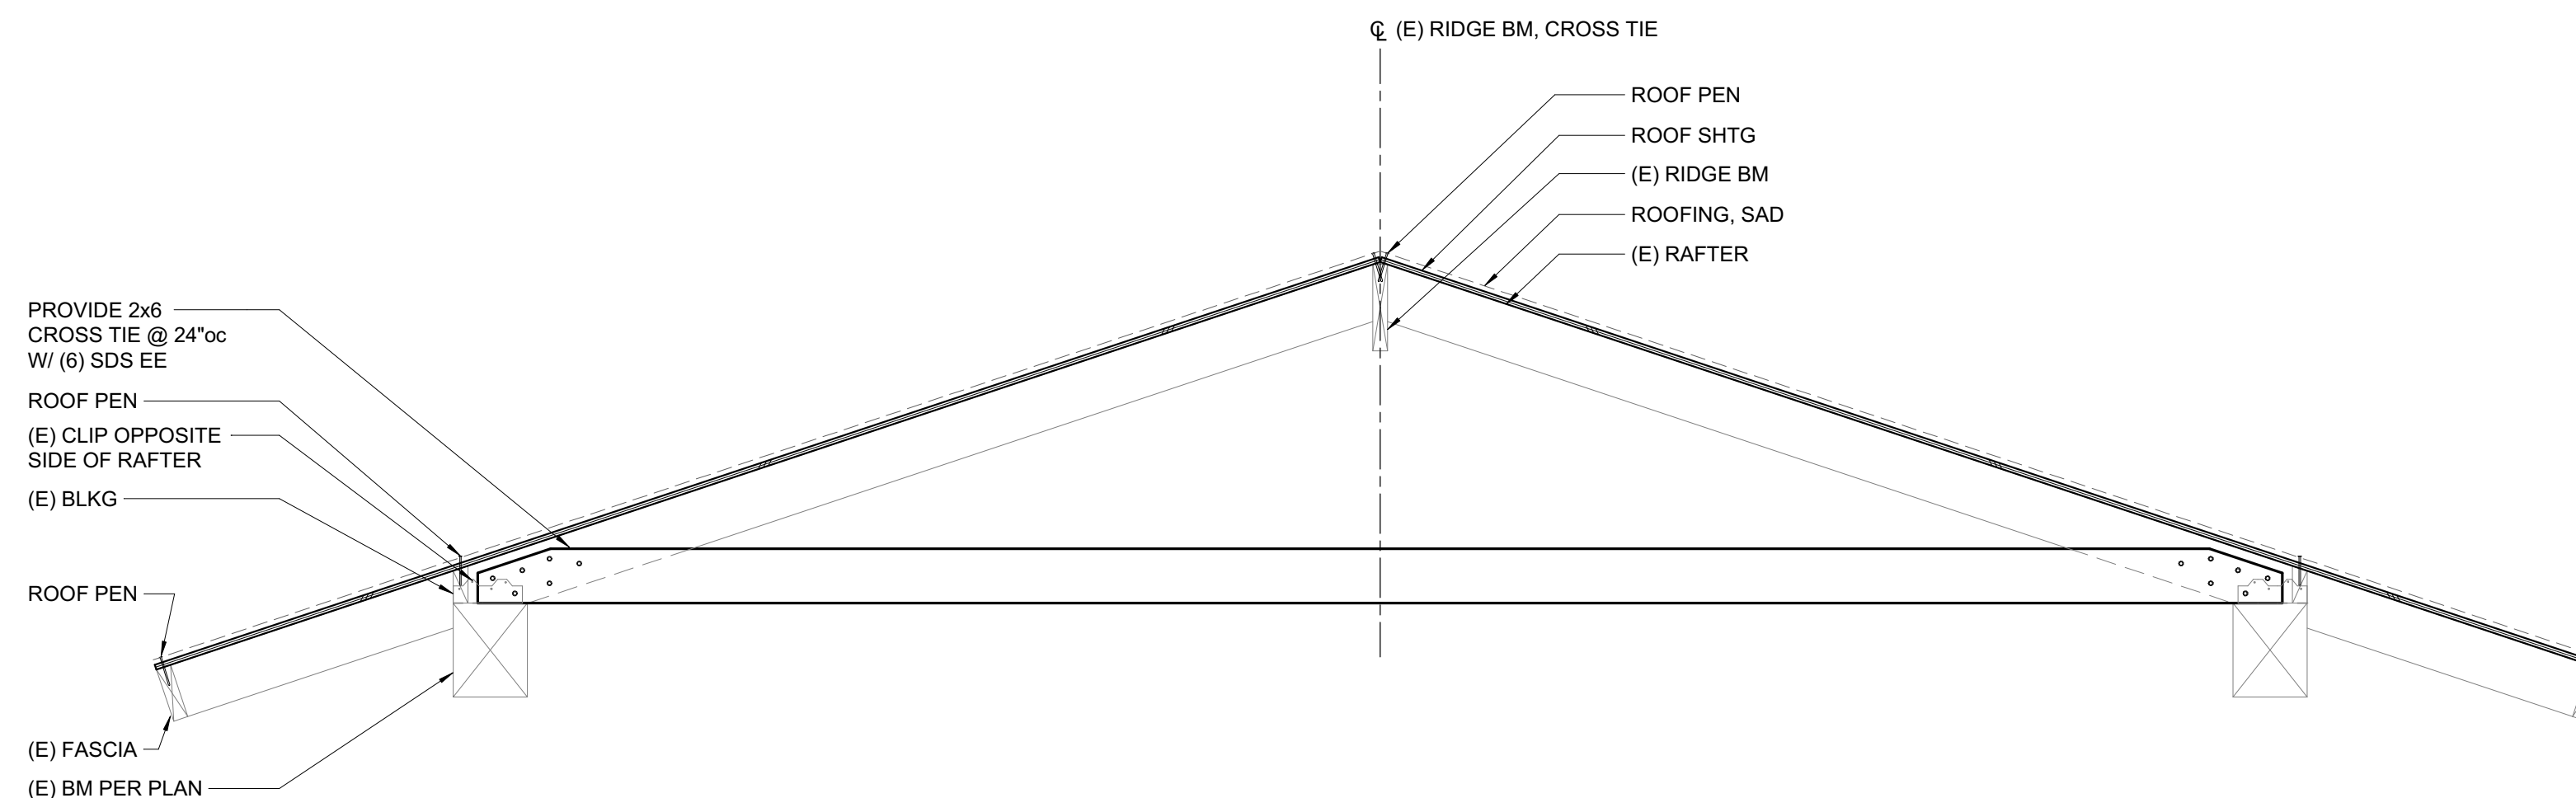

1 CROSS TIE AT ROOF FRAMING

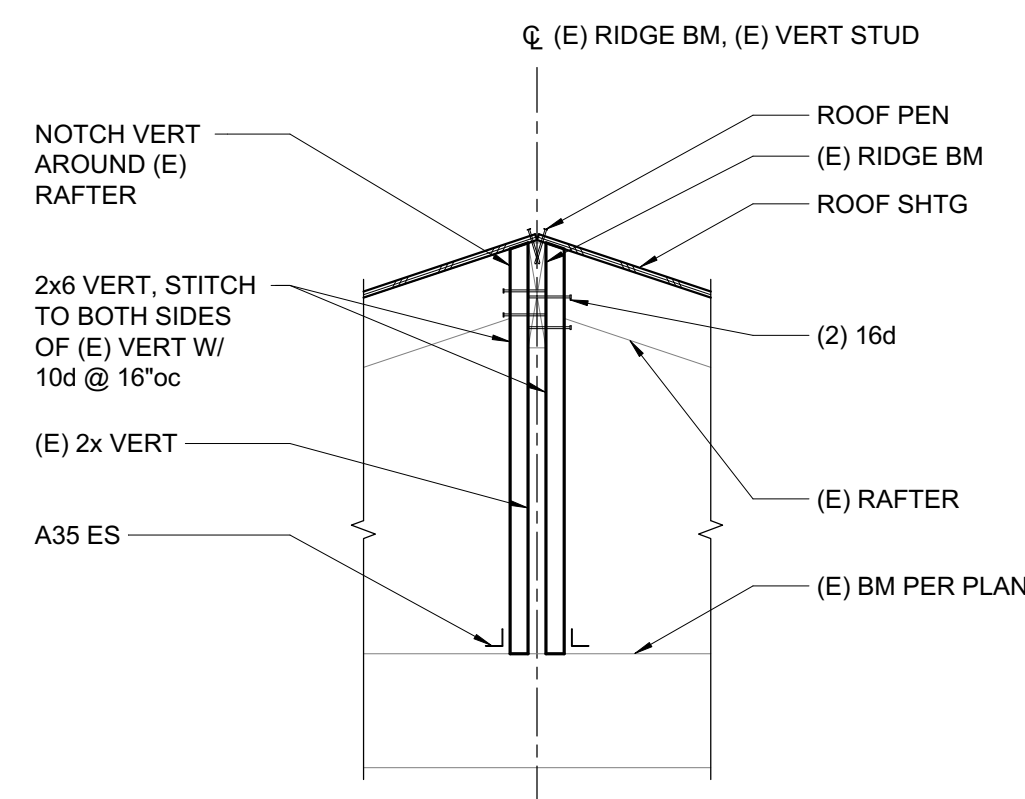


$$\frac{3}{4}'' = 1'-0''$$


2 VERTICAL SUPPORT AT RIDGE

$$\frac{3}{4}'' = 1'-0''$$

**FRAMING PLAN NOTES:**

1. REFER TO SHEET **S1** FOR GENERAL NOTES AND TYPICAL DETAILS. THE FOLLOWING DETAIL REFERENCES ARE PROVIDED FOR THE CONTRACTOR'S CONVENIENCE ONLY. ALL GENERAL NOTES AND TYPICAL DETAIL SHEETS NOTED ABOVE ARE APPLICABLE AND SHALL BE FOLLOWED.
2. ELEVATIONS ON PLANS AND DETAILS **5'-0"** ARE TO HEIGHTS ABOVE FINISHED GROUND FLOOR ELEVATION REFERENCE 0'-0". COORDINATE TOP OF FRAMING AND LEDGER HEIGHTS AS REQUIRED TO PROVIDE ROOF SLOPES AS SHOWN ON ALL ARCHITECTURAL AND STRUCTURAL DRAWINGS PRIOR TO CONSTRUCTION. NOTIFY ARCHITECT/ENGINEER OF ANY DISCREPANCIES.

PLAN LEGEND		
SYMBOL	REFERENCE DETAIL	DESCRIPTION
		INDICATES STEEL COLUMN.
	<u>D/S1</u>	INDICATES HANGER.
		INDICATES EXISTING FRAMING.

C:\REVIT\_LOCAL\18186.01\_Kaseburg Gazebo Retrofit\_S17C\_robertr@zfa.com.rvt

6/26/2018 3:38:13 PM

## Permit Set

<b>Permit Set</b> For Council approval Do Not Use for bidding	ENGR:	RR	DATE: 6/26/2018
	PM:	MCK	
	SHEET		
		<b>S2</b>	